- Cover Sheet
- 2 Site Plan
- 3 Site Grading Plan
- Landscape Plan
- 5 Landscape Details and Notes
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- Utility plan 8 Utility Detail sheet 1
- 9 Site Details Sheet 2
- 10 Address & Traffic Control
- 11 Lighting site plan
- 12 Photometric plan
- 13 Floor plan
- 14 Elevations
- 15 Sections & Elevation details

#### **PROJECT TEAM**

Architect
Waugh and Associates Architects/Planners 71 Bowen St. Longmont, CO 80501

720-494-7602 Contact: David Waugh Email: info@waughworld.com

Structural Engineer Peak Engineering, Inc. Consulting Structural Engineering 1687 Cole Boulevard Lakewood, CO 80401 303-274-0707

Contact: John Email: jhart@peakengr.com

MECHANICAL / ELECTRICAL PLUMBING ENGINEER NFE Engineering Services Johnstown, CO

970-587-7100 Contact: Ross Nichols Email: ross7777@aol.com

**CIVIL ENGINEER** BenchMark Engineers, PC 1920 Thomes Ave. Suite 200 Cheyenne, Wyoming 82001 307-634-9064

Contact: Kelly Hafner Email: kellyh@benchmarkengineers.com

Owner
Bluestem Tech Center LLC, a Colorado limited liability company John-Peter B. D'Amico, Member 2727 Madison Drive Longmont, CO 80503 303-818-1919 Contact: John D'Amico Email: johndamico81@msn.com

### FINAL DEVELOPMENT PLAN

# BLUESTEM TECH CENTER

**COVER SHEET** TOWN OF FIRESTONE, WELD COUNTY, STATE OF COLORADO 11052 CIMARRON STREET SHEET 1 OF 15

LEGAL DESCRIPTION

ALL OF LOT 2, BLOCK 2, OF FIRESTONE CENTER, FIRST REPLAT, RECORDED ON 5/24/2004 AT RECEPTION NO.3182747 AT THE OFFICE OF THE WELD COUNTY CLERK AND RECORDER, BEING LOCATED IN THE SE1/4 OF SECTION 1,T2N, R68W OF THE 6th PM, TOWN OF FIRESTONE, COUNTY OF WELD, STATE OF COLORADO.

Containing 58,069 SQUARE FEET, OR 1.33 ACRES, MORE OR LESS

This Final Development Plan (FDP) is for the Bluestem Tech Center at the Firestone Center Development, which is located on Lot 2, Block 2, of the Firestone Center Subdivision, First Replat. A 12,480 SF Commercial, Retail, Office building shall be constructed on the 58,069 SF lot. The concept plan for this project is to construct a high quality business center that will attract regional commercial businesses. Contemplated uses are medical, dental, engineering, research and development, insurance and uses that are commercial and/or office related. Restaurants are permitted, providing the necessary water to operate them is dedicated to the town. The building shall not be divided into multiple ownerships and may be divided into separate tenant leases.

ZONING
This lot is zoned Planned Unit Development ("PUD") with the Regional Commercial land use category as specified in the Mountain Shadows Outline Development Plan recorded September 13, 2000. Note: Industrial and warehouse land uses are not permitted in the Regional Commercial land use category.

The building height shown in this FDP is 22 feet, which is less than the maximum building height of 50 feet which is currently permitted pursuant to the Firestone Development Regulations for the Regional Commercial Land Use Category.

Gross Site Area:	1.33 Acres	58,069 Square Feet	100%
Estimated Floor Area:	.2865 Acres	12,480 Square feet	21%
Public ROW:	0 Acres	0 Square Feet	0%
Net Site Area: Parking, Drives, Walks	1.0435 Acres s, Landscaping	45,319 Square Feet	79%
LAND USE TABLE			
Building Coverage:	.2865 Acres	12,480 Square Feet	22%
Parking, Drives and W	alks: .836 Acres	36,425 Square Feet	62%

Landscape Areas: Existing .038 Acres 1,655 Square Feet 3% Proposed .172 Acres 7,357 Square Feet 13% Parking Allowances: Parking Provided Parking / Sq. Ft. Business/ Commercial 48 Spaces 1/ 260 Sa. Ft

Bicycle Parking: Provided Required 5% Vehicle Parking 4 spaces Fixed 2.4 Fixed

**ENVIRONMENTAL IMPACT MITIGATION** There is no evidence of recognized environmental conditions in connection with this site. No wetlands are located at the site.

PRIVATE MAINTENANCE AND ENFORCEMENT This site will be privately maintained. Necessary cross access and utility easements, as well as agreements for any common roadways and /or access

points are provided as part of the Firestone Center Development. PARKS, TRAILS AND OPEN SPACE

No new parks, trails, or open space, are provided with this FDP. The Existing Landscaping identified on page four (4) of the Landscape plan shall be replaced to comply with the Firestone Center Subdivision and maintained by the owner.

This FDP Site Plan has been designed to comply with the American's With Disabilities Act.

**REAR OVERHEAD DOOR USE AND RESTRICTIONS** 

The rear overhead doors will be used for loading and unloading materials, equipment and goods into the building. These doors are to remain closed at all other times. Maximum time limit for loading and unloading shall be one hour between the hours of 8:00 am to 6:00 pm Monday through Saturday.

WATER METER TABLE

QUANTITY	SIZE	TYPE
1	1"	COMMERCIAL
0	_	IRRIGATION

One (1) Monument sign shall be located at the main center entrance of the lot within the landscape buffer. The "Bluestem Tech Center" sign shall match the building architectural theme and be low-lying with lighting projected towards the sign to minimize projection of light. The front facade c. the building shall have individual signage for each tenant. The monument sign shall be no more than three (3) feet above grade and no more than 24 feet long.

No temporary signs shall be allowed on the exterior of the building. No vinyl coverings shall be affixed to the glass that exceeds 5% coverage. No inflatable advertising shall be allowed on the property or building.

The front façade (south elevation) of the building shall have individual signage for each tenant (Tenant Signs). No other lighted signs shall be allowed on the building or grounds.

All signs shall be consistent with the size, shape and type noted within the Final Development Plan drawings although actual letters', sign text, material, mounting height and area may change from the depicted drawings. The owner reserves the right to not install any of the Tenant Signs shown on the Final Development Plan drawings. All other signs shall be installed by the developer as depicted in the Final Development Plan drawings, including but not limited to the Monument sign, rear (north) signage that is not lighted and directional signs. Signs located at the north side of the building shall not be lighted.

SPECIFIC SIGN CRITERIA

Monument sign shall be constructed of a concrete face and base to match front façade of building. Overall size will be 3'x24' depicting "Bluestem Tech Center" with address. The maximum letter height shall be 18". Two ground mounted directional lights on each side of sign illuminating the sign only. Directional signs shall be post mounted metal painted signs on 20 gauge sheet metal. Maximum size shall be 24" x 24". Posts shall be 2"x2" aluminum or steel tube set 3' into finished grade. Maximum overall height shall be 8'-6" above finished grade.

**PARKING RESTRICTIONS** 

No storage container shall be permitted on site except for loading and unloading. No materials or equipment shall be stored outside the building. The rear parking area shall be limited to customers and employees of the building and shall not be used for storage of any kind. Maximum time limit for loading and unloading shall be one hour between the hours of 8:00 am to 6:00 pm Monday through Saturday.

**CONTROLS** 

The declaration of reciprocal easements and restrictions are provided as part of the Firestone Center Development.

SITE SPECIFIC RESTRICTIONS

Outdoor seating shall be allowed only at the south side of the building. Any outdoor music shall be no louder than the exiting decibel reading allowed by the town. Speakers shall be allowed on the south side of the building only.

**DRAINAGE AND GRADING** 

Refer to the final drainage letter for a description of the Storm Drainage for this FDP. The letter is dated July 1, 2016 and was prepared Benchmark of Chevenne, P.C. The letter is filed with this FDP. An area drainage facility is included with this project. The detention facility is located in Tract A, Firestone

<u>UTILITIES</u>

- The Development shall be served by the following utility companies: 1. Gas - Black Hills Energy
  - 2. Power United Power
  - 3. Telephone Century Link
  - 4. Water Town of Firestone
  - 5. Sanitary Sewer St. Vrain Sanitation District 6. Police - Town of Firestone
  - 7. Fire Frederick-Firestone Fire Protection District
- 8. Recreation Carbon Valley Recreation District

WATER DEMAND CALCULATION

Water dedication was determined based on information provided by the owner. The total amount of CBT water dedicated to the town was calculated based on acres of irrigated landscaping on the site and total estimated domestic (in building) demand. The town shall at all times have the right to secure additional water dedication if actual consumption exceeds this calculated estimate. If the town determines that additional CBT water is to be dedicated, the lot owner shall provide the water within 30 days written notice by the town. The additional dedication shall be based on the towns then current water dedication policies.

The town of Firestone has determined the required CBT dedication to be;

Irrigation Demand = 0.43 CBT Units Domestic Demand = 2.50 CBT Units

A total of three (3) CBT units shall be transferred to the town of Firestone prior to issuance of any certificate of occupancy.

\*The water dedication for the existing landscaping along the north of this lot is not included in any of these calculations, because the water dedication was previously satisfied with the Firestone Center FDP Rec. No. 3100399.

A freestanding 12,480 sq. ft., single story building designed as "B" occupancy and a Type "IIIB" construction shall be constructed at the site. The building shall be designed with a high quality contemporary architectural look, using a complimentary color and accent scheme. The overall building background will be painted Sleek White, SW1018. The overhead doors and accent areas will be painted Skyline Steel SW1015. The awnings, and building sign mounts will be painted aluminum metallic. This color scheme is designed to fit with other existing building color schemes located in the Firestone Center. The exterior materials include Tilt-Wall concrete and full-front glass. The roof material will be made up of a steel deck covered with 3" rigid insulation with a TPO cover. The architectural theme is consistent with the Firestone Center and similar in character to the UCHealth Emergency Clinic.

Principal building setbacks are as dimensioned on the FDP, see Site Plan sheet. All setbacks meet Firestone Development Regulations and Building Codes.

Minimum building setbacks require that no building shall be constructed: on utility or drainage easements; or within 200' of the existing gas well site located on Tract A.

The east elevation of the building is set back 17.2', the north elevation of the building is set back 71', the south elevation of the building is set back 126' and the west elevation of the building is set back 21.5'.

**DEVELOPMENT SCHEDULE** 

Construction Start: Third quarter, 2016 Tech Center opening: First quarter, 2017

Submission to the Building Department is projected to begin after acceptance of the Final Development Plan by the Town of Firestone. Construction of the building is projected within six (6) months of building approval.

ACCEPTANCE BLOCK AND NOTARY

By signing this Final Development Plan, the Owner acknowledges and accepts all of the requirements and intent set forth within.

Schet B. Donin

Bluestern Tech Center, LLC, a Colorado limited liability company John-Peter B. D'Amico, Member

State of Colorado

County of Weld


The foregoing instrument was acknowledged before me this HM day of OCTORW, 2016, by JOHN-PETER B. D'AMICO

Witness my hand and official seal



Eliphan Realt 10-19-2019 My Commission expires

APPROVAL

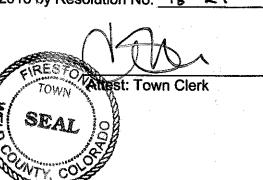

FIRESTO	NE INFORMATION BLOCK
	COVER SHEET
NAME OF SUBMITTAL:	BLUESTEM TECH CENTER
TYPE OF SUBMITTAL:	FINAL DEVELOPMENT PLAN
FILING NUMBER:	N/A
PHASE NUMBER:	N/A
PREPARATION DATE:	04/15/2016
REVISION DATE:	06/20/2016
REVISION DATE:	07/01/2016
REVISION DATE:	08/18/2016
REVISION DATE:	09/29/2016
REVISION DATE:	
	SHEET 1 OF 15

Owner
Bluestern Tech Center LLC, a Colorado limited liability company John-Peter B. D'Amico, Member 2727 Madison Drive Longmont, CO 80503 303-818-1919 Contact: John D'Amico Email: johndamico81@msn.com

REVISIONS:

DRAWN BY: T. WAUGH

COLORADO

STONE,

INTER FIRES

TECH

BLUI CENTER

FIRESTONE

waug

15 APRIL 2016

COVER


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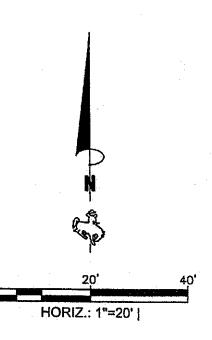
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PROPOSED BLE				
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<ol> <li>ALL TREES AND SHRUBS SHALL BE ON</li> <li>NEAREST FIRE HYDRANT SOUTH ACCE</li> </ol>			SOUTH LOT LINE	
	LEE HOND INFERIOR 2		Davis of the State	
SITE PLAN COMP	NOITATU	IS		
AREA SUMMARY:				
LOT AREA	1.33 ACRES	******		
SITE PLAN AREA (LOT)	58,069 S.F.	(100%)		
NEW BUILDING AREA COVERAGE	E: 12,480 S.F. 32,611 S.F.	(21.5%) (56.2%)		•
PARKING ,WALKS, & DRIVES: SITE COVERAGE:	45,091 S.F.	(77.7%)		
LANDSCAPED AREA	40,031 0.1.	(11.170)		
EXISTING TO REMAIN NEW	7,092 S.F.	(5.2%) (12.2%)		
TOTALS	10,114 S.F.	(17.4%)		
PEDESTRIAN-SCAPE	2,869 S.F	(4.9%)		
BUILDING PROVISIONS:	00 FT			•
	22 FT. 12,480 SQ. FT.			
	PROVIDED	REQUIRED		
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## BLUESTEM TECH CENTER

SITE PLAN

TOWN OF FIRESTONE, WELD COUNTY, STATE OF COLORADO





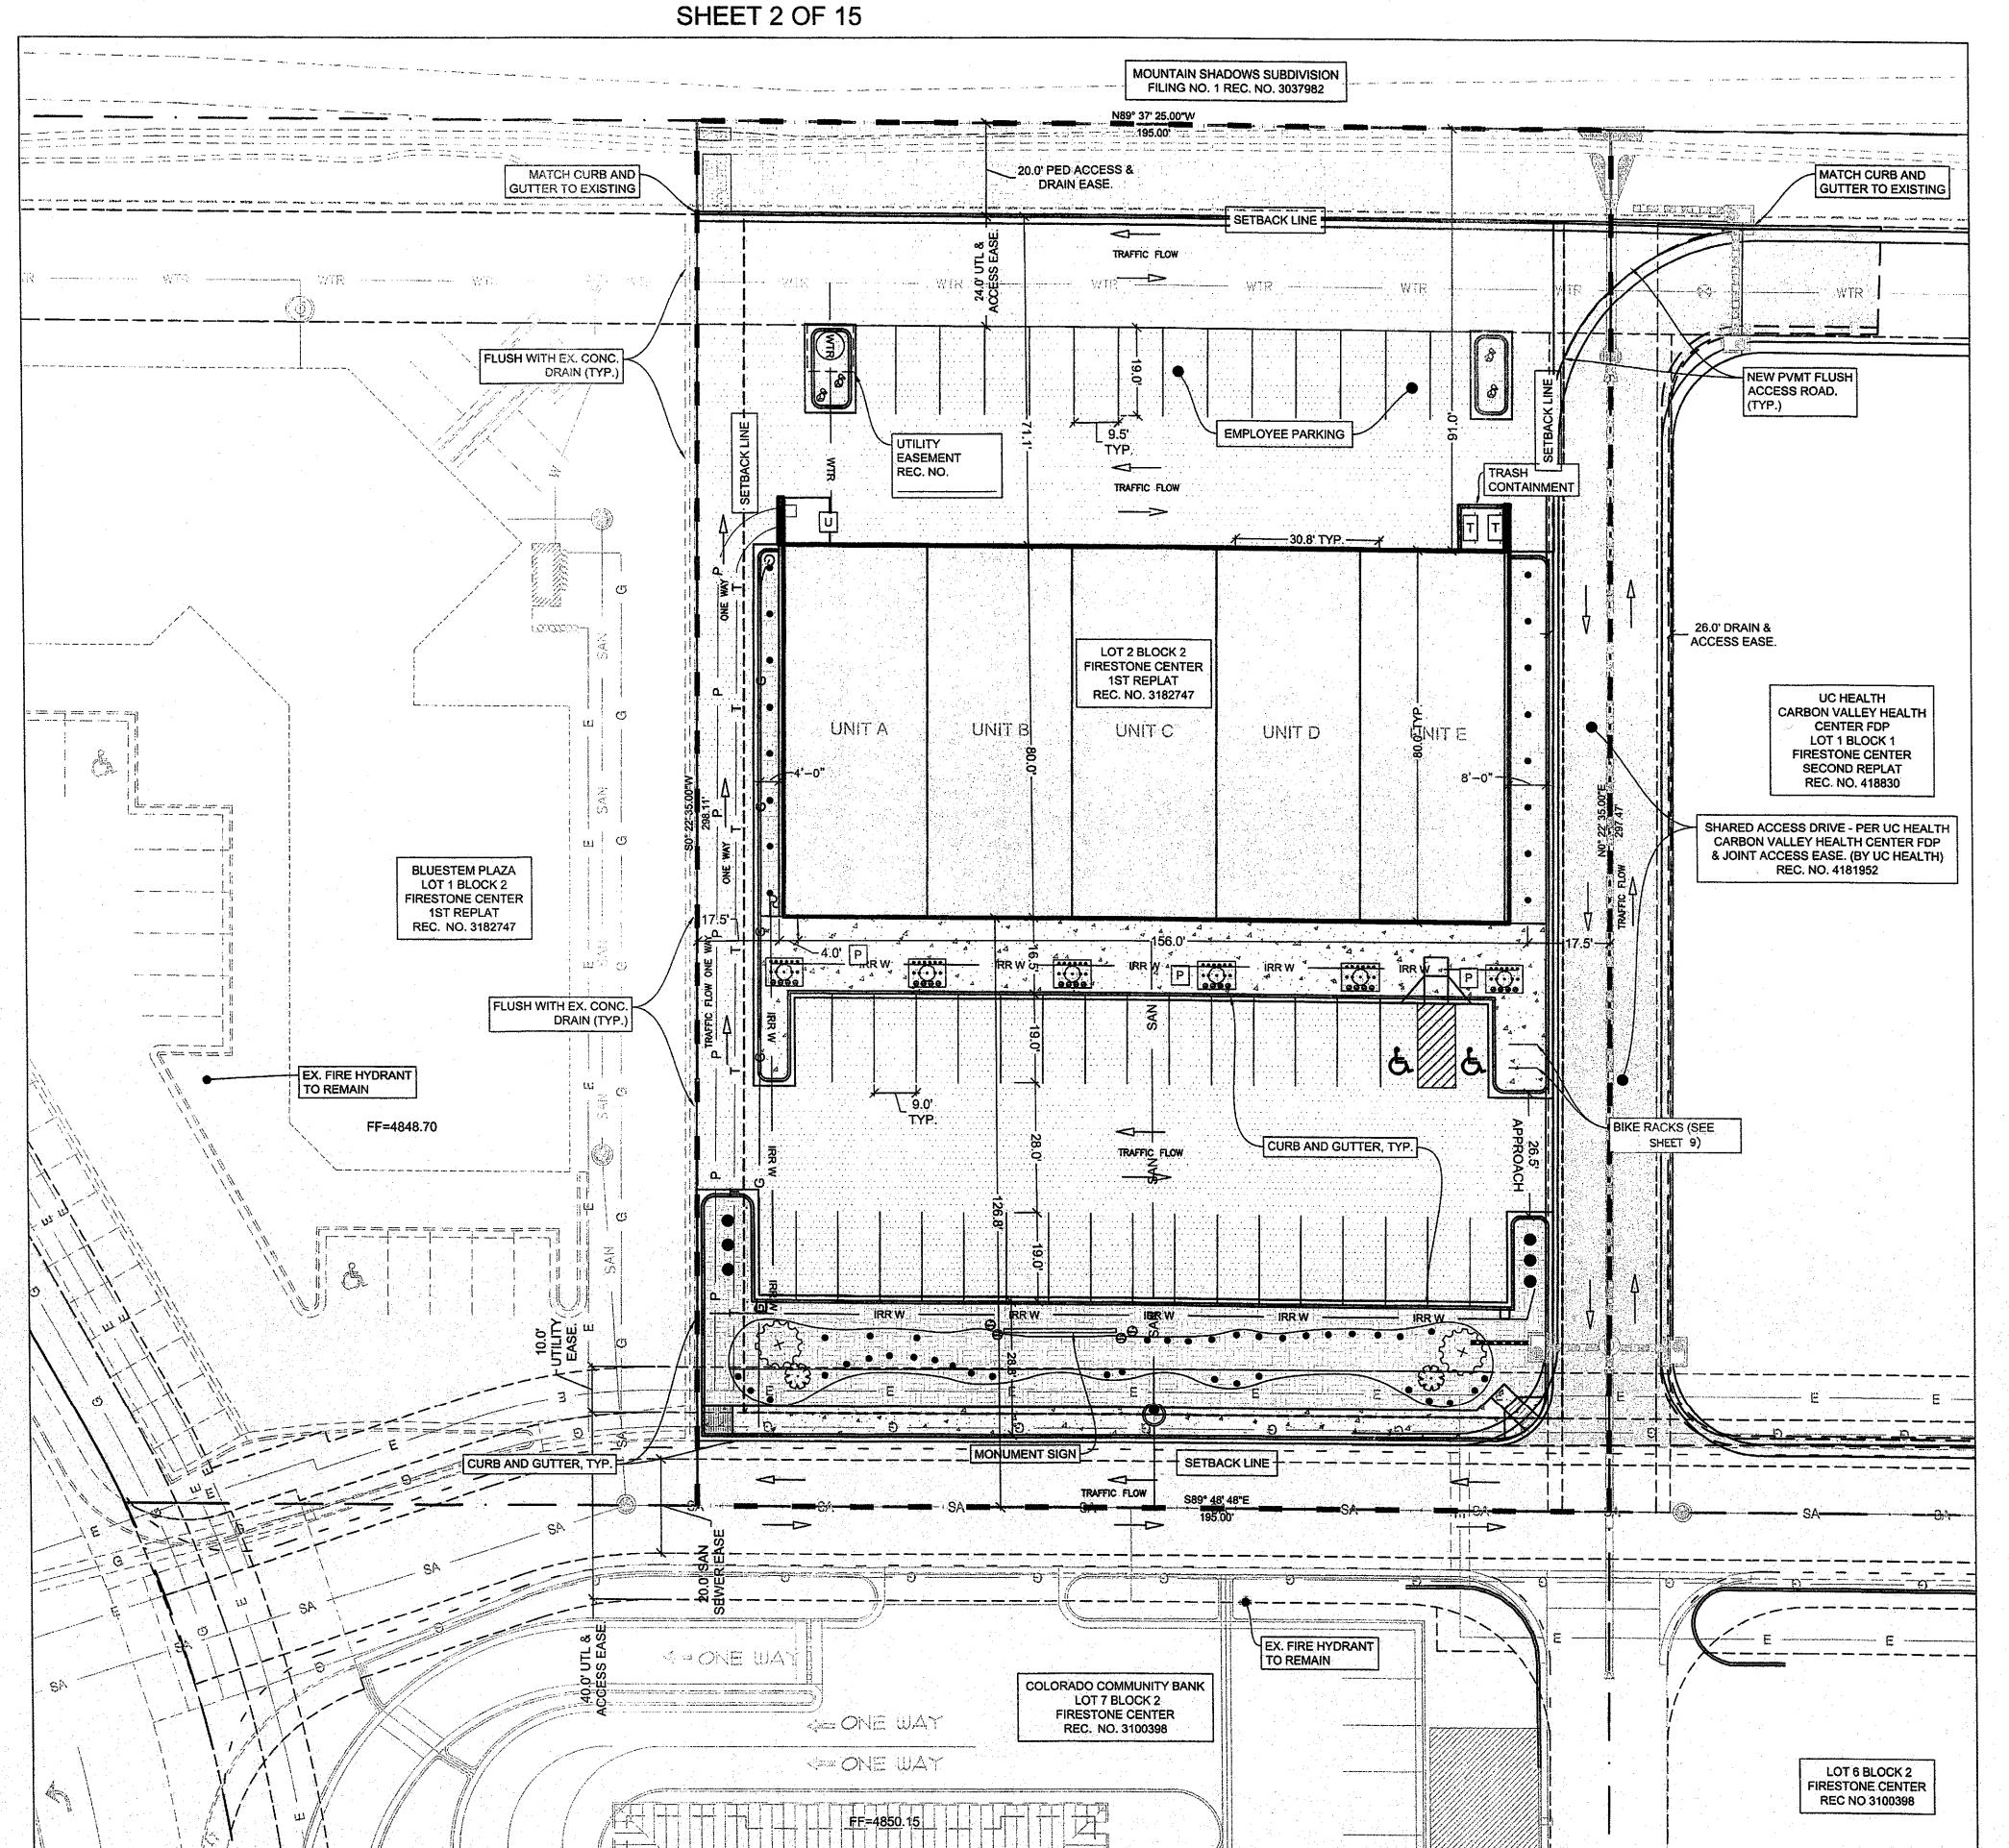


#### BenchMark

engineers, Po

1920 THOMES AVENUE SUITE 200 CHEYENNE, WY 82001 307.634.9064 www.BenchMarkEngineers.com

	SITE PLAN	
NAME OF SUBMITTAL:	BLUESTEM TECH CENTER	
TYPE OF SUBMITTAL:	FINAL DEVELOPMENT PLAN	
FILING NUMBER:	N/A	
PHASE NUMBER:	N/A	···
PREPARATION DATE:	04/15/2016	
REVISION DATE:	06/20/2016	
REVISION DATE:	07/01/2016	
REVISION DATE:	08/18/2016	
REVISION DATE:	09/29/2016	
REVISION DATE:		
	SHEET 2 OF 15	

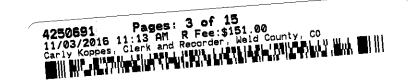

### BLUESTEM TECH CENTER

SITE GRADING PLAN TOWN OF FIRESTONE, WELD COUNTY, STATE OF COLORADO SHEET 3 OF 15

LEGEND PROPERTY LINE PROPOSED PERIMETER EROSION PROTECTION 0-0 0 0 STORM SEWER - EXISTING/PROPOSED TO THE STORM SEWER - EXISTING/PROPOSED DITCH/SWALE LINE -> -> -> CONTOURS - EXISTING / PROPOSED 0000.00 - / - 0000.00 -GENERAL DRAINAGE DIRECTION \_\_\_\_\_ FINISHED FLOOR ELEVATION FFE TOP OF CONCRETE SLAB OR SIDEWALK TOS EXISTING GRADE EG FLOWLINE FL FINISH GRADE FG TOP BACK OF CURB TBC HIGH POINT HP

#### **GRADING AND EROSION CONTROL NOTES**

#### **GENERAL GRADING NOTES**

- VERTICAL DATUM: NGVD 29 AS ESTABLISHED BY KING SURVEYORS.
- GEOTECHNICAL REPORT AND REFERENCE:

GEOTECHNICAL ENGINEERING REPORT, BORGMANN PROPERTY NORTHWEST OF WELD COUNTY ROADS 13 & 24 BY TERRACON, DATED JAN 7, 2000.

PROJECT GENERAL SPECIFICATIONS:

TOWN OF FIRESTONE GENERAL SPECIFICATIONS AND STANDARD DETAILS (CURRENT EDITION) OBTAINED AT WWW.FIRESTONE.GOV UNDER ENGINEERING, CONSTRUCTION STANDARDS AND SPECIFICATIONS.

ENGINEERING FILL MATERIAL AND BED COURSE MATERIALS (OUTSIDE OF BUILDING SECTIONS) SHALL BE PLACED AND COMPACTED IN HORIZONTAL LIFTS AND SHALL MEET THE FOLLOWING COMPACTION REQUIREMENTS:

#### MINIMUM PERCENT

. 95%-100% (- 3% TO + 2% OPTIMUM MOISTURE CONTENT)

(ASTM D698)
-- 95-98% (+/- 2% OPTIMUM MOISTURE CONTENT) 3. ON-SITE AND IMPORTED FILL SOILS: BENEATH FOUNDATIONS

BENEATH CIVIL LANDSCAPED AREAS . SCARIFY EXISTING SOILS - LIMIT COMPACTION OF NEW FILL 90%-92% · 95% (+/- 2% OPTIMUM MOISTURE CONTENT) 4. AGGREGATE BASE COURSE 95%-100% (- 4% TO + 2% OPTIMUM MOISTURE CONTENT) 5. MISCELLANEOUS TRENCHING & BACKFILL.

ROADWAYS INCLUDE PARKING LOT DRIVE AREAS AND STALLS. MAXIMUM LIFTS = 8" FOR EARTHWORK EMBANKMENT. REMOVAL AND/OR IMPORT FOR EXCAVATION AND EMBANKMENT MATERIALS SHALL BE RESPONSIBILITY OF THE CONTRACTOR. IMPORTED SOILS

PERCENT PASSING BY WEIGHT

FOR CIVIL SITE WORK SHALL MEET CRITERIA OUTLINED BELOW:

GRADATION (ASTM C136)

70-100% No. 4 Sieve 50-100% No. 200 Sieve 40% (MAX.)

> LIQUID LIMIT 30 (MAX.) PLASTICITY INDEX 15 (MAX.)

OTHERWISE SPECIFIED ON THE LANDSCAPE PLAN ASSUME DIRT GRADE IN LANDSCAPE AREAS IS 6-INCHES BELOW FINISHED GRADE SHOWN ON THESE PLANS.

SEE OTHER SHEETS FOR SURFACING SECTIONS.

#### **EROSION CONTROL**

THE CONTRACTOR SHALL BE RESPONSIBLE FOR ALL STORMWATER & EROSION CONTROL PERMIT ASPECTS INCLUDING DEVELOPMENT, IMPLEMENTING, AND MAINTAINING A STORMWATER POLLUTION PREVENTION PLAN (SWPPP) THROUGH SUBSTANTIAL COMPLETION OR AS OTHERWISE APPROVED BY THE OWNER.

THE CONTRACTOR SHALL INCLUDE IN THE PERMIT REQUIRED STORMWATER MANAGEMENT PLAN (SWMP OR SWPPP) PROVISIONS TO CONTROL STORMWATER RUNOFF, DUST AND MUD FROM ALL ANTICIPATED CONSTRUCTION ACTIVITIES AND ADJOINING PAVED STREETS. STORM SEWER AND CHANNELS; PER PERMIT AND CITY/STATE REQUIREMENTS.

#### SWMP & SWPPP NOTES:


TOTAL PROJECT: AREA OF DISTURBANCE:


1.33 ACRES +/-1.10 ACRES +/-

WATERSHED: ST. VRAIN RIVER **CLOSEST STORM SEWER:** ADJOINING ACCESS ROAD (EAST SIDE OF PROJECT)


PRE-DEVELOPMENT SITE: POST DEVELOPMENT SITE: 8% IMPERVIOUS 83% IMPERVIOUS

PERIMETER EROSION CONTROL PROTECTION AND TRACKING CONTROL PAD REQUIRED ONLY UNTIL TIME OF PAVING PARKING LOT

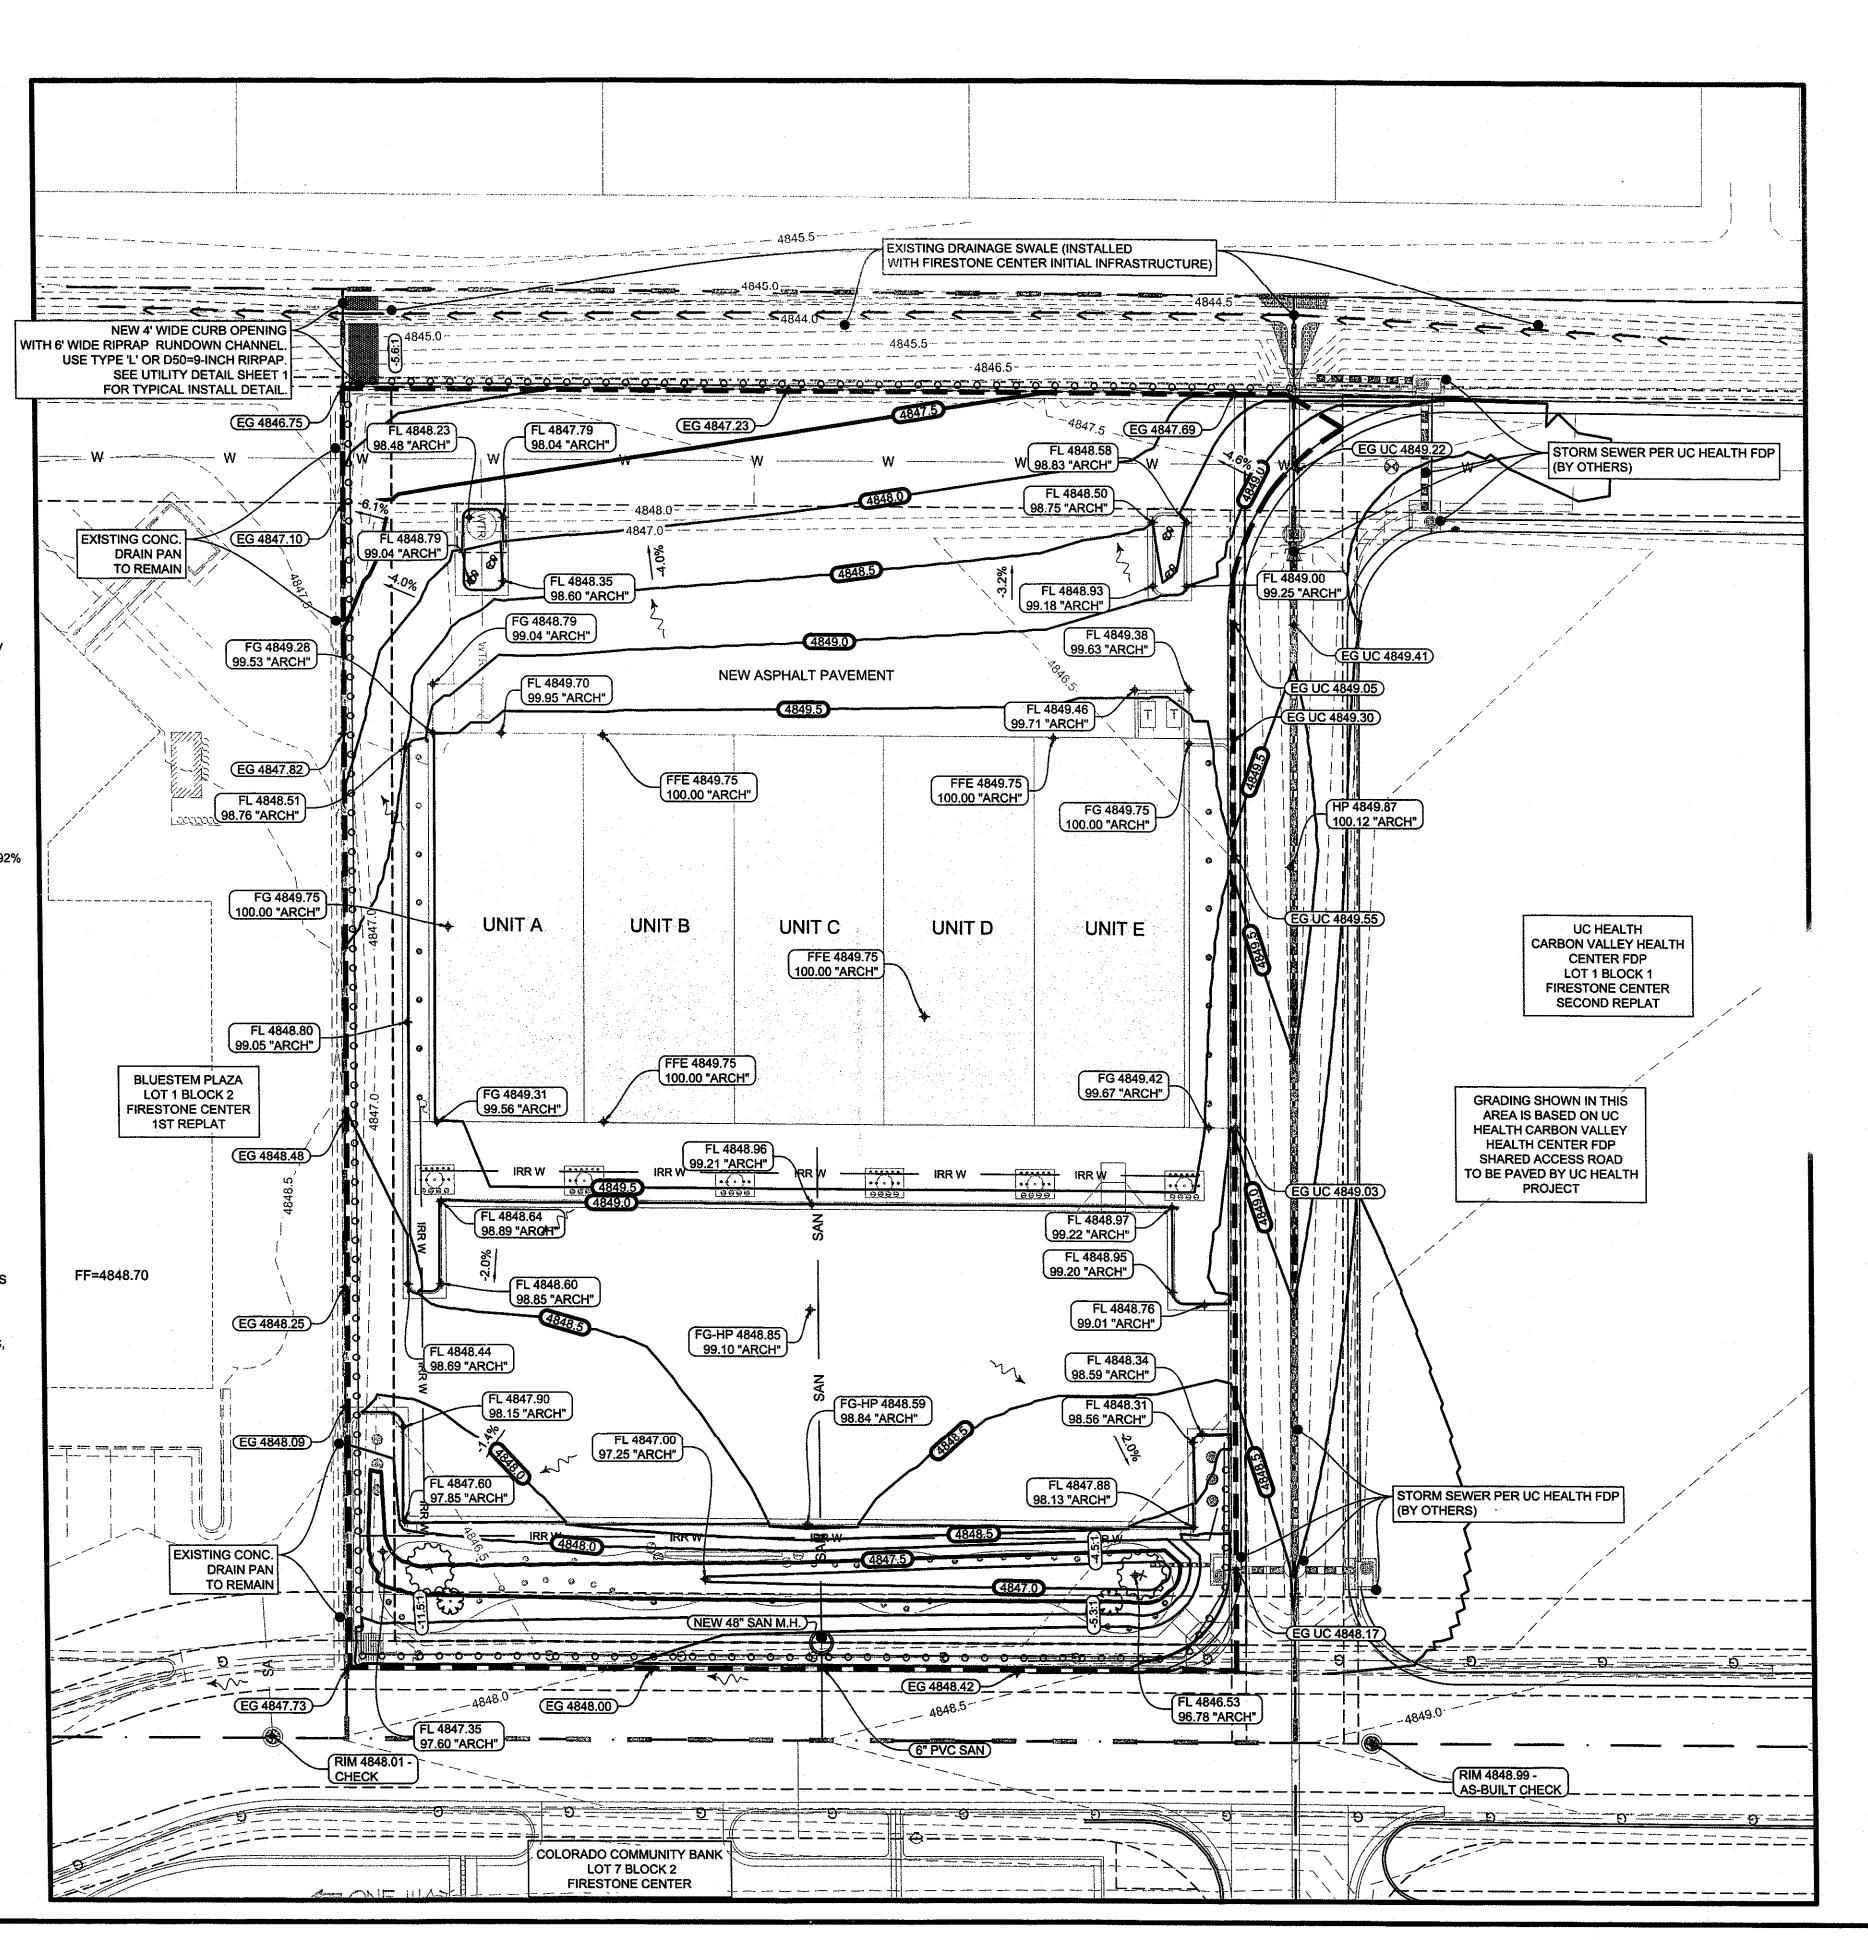

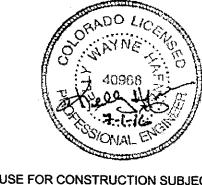

USE FOR CONSTRUCTION SUBJECT TO TOWN OF FIRESTONE DEVELOPMENT AND PERMIT APPROVALS

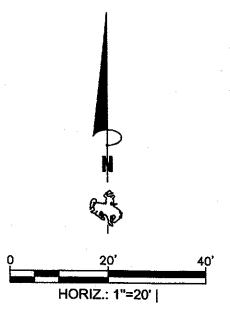




#### **BenchMark** engineers, PC


1920 THOMES AVENUE SUITE 200 CHEYENNE, WY 82001 307.634.9064 www.BenchMarkEngineers.cor

SI	TE GRADING PLAN
ME OF SUBMITTAL:	BLUESTEM TECH CENTER
YPE OF SUBMITTAL:	FINAL DEVELOPMENT PLAN
ILING NUMBER:	N/A
PHASE NUMBER:	N/A
PREPARATION DATE:	04/15/2016
REVISION DATE:	06/20/2016
REVISION DATE:	07/01/2016
REVISION DATE:	08/18/2016
REVISION DATE:	09/29/2016
REVISION DATE:	
	SHEET 3 OF 15

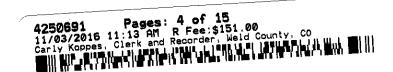

### BLUESTEM TECH CENTER

LANDSCAPE PLAN
TOWN OF FIRESTONE, WELD COUNTY, STATE OF COLORADO
SHEET 4 OF 15

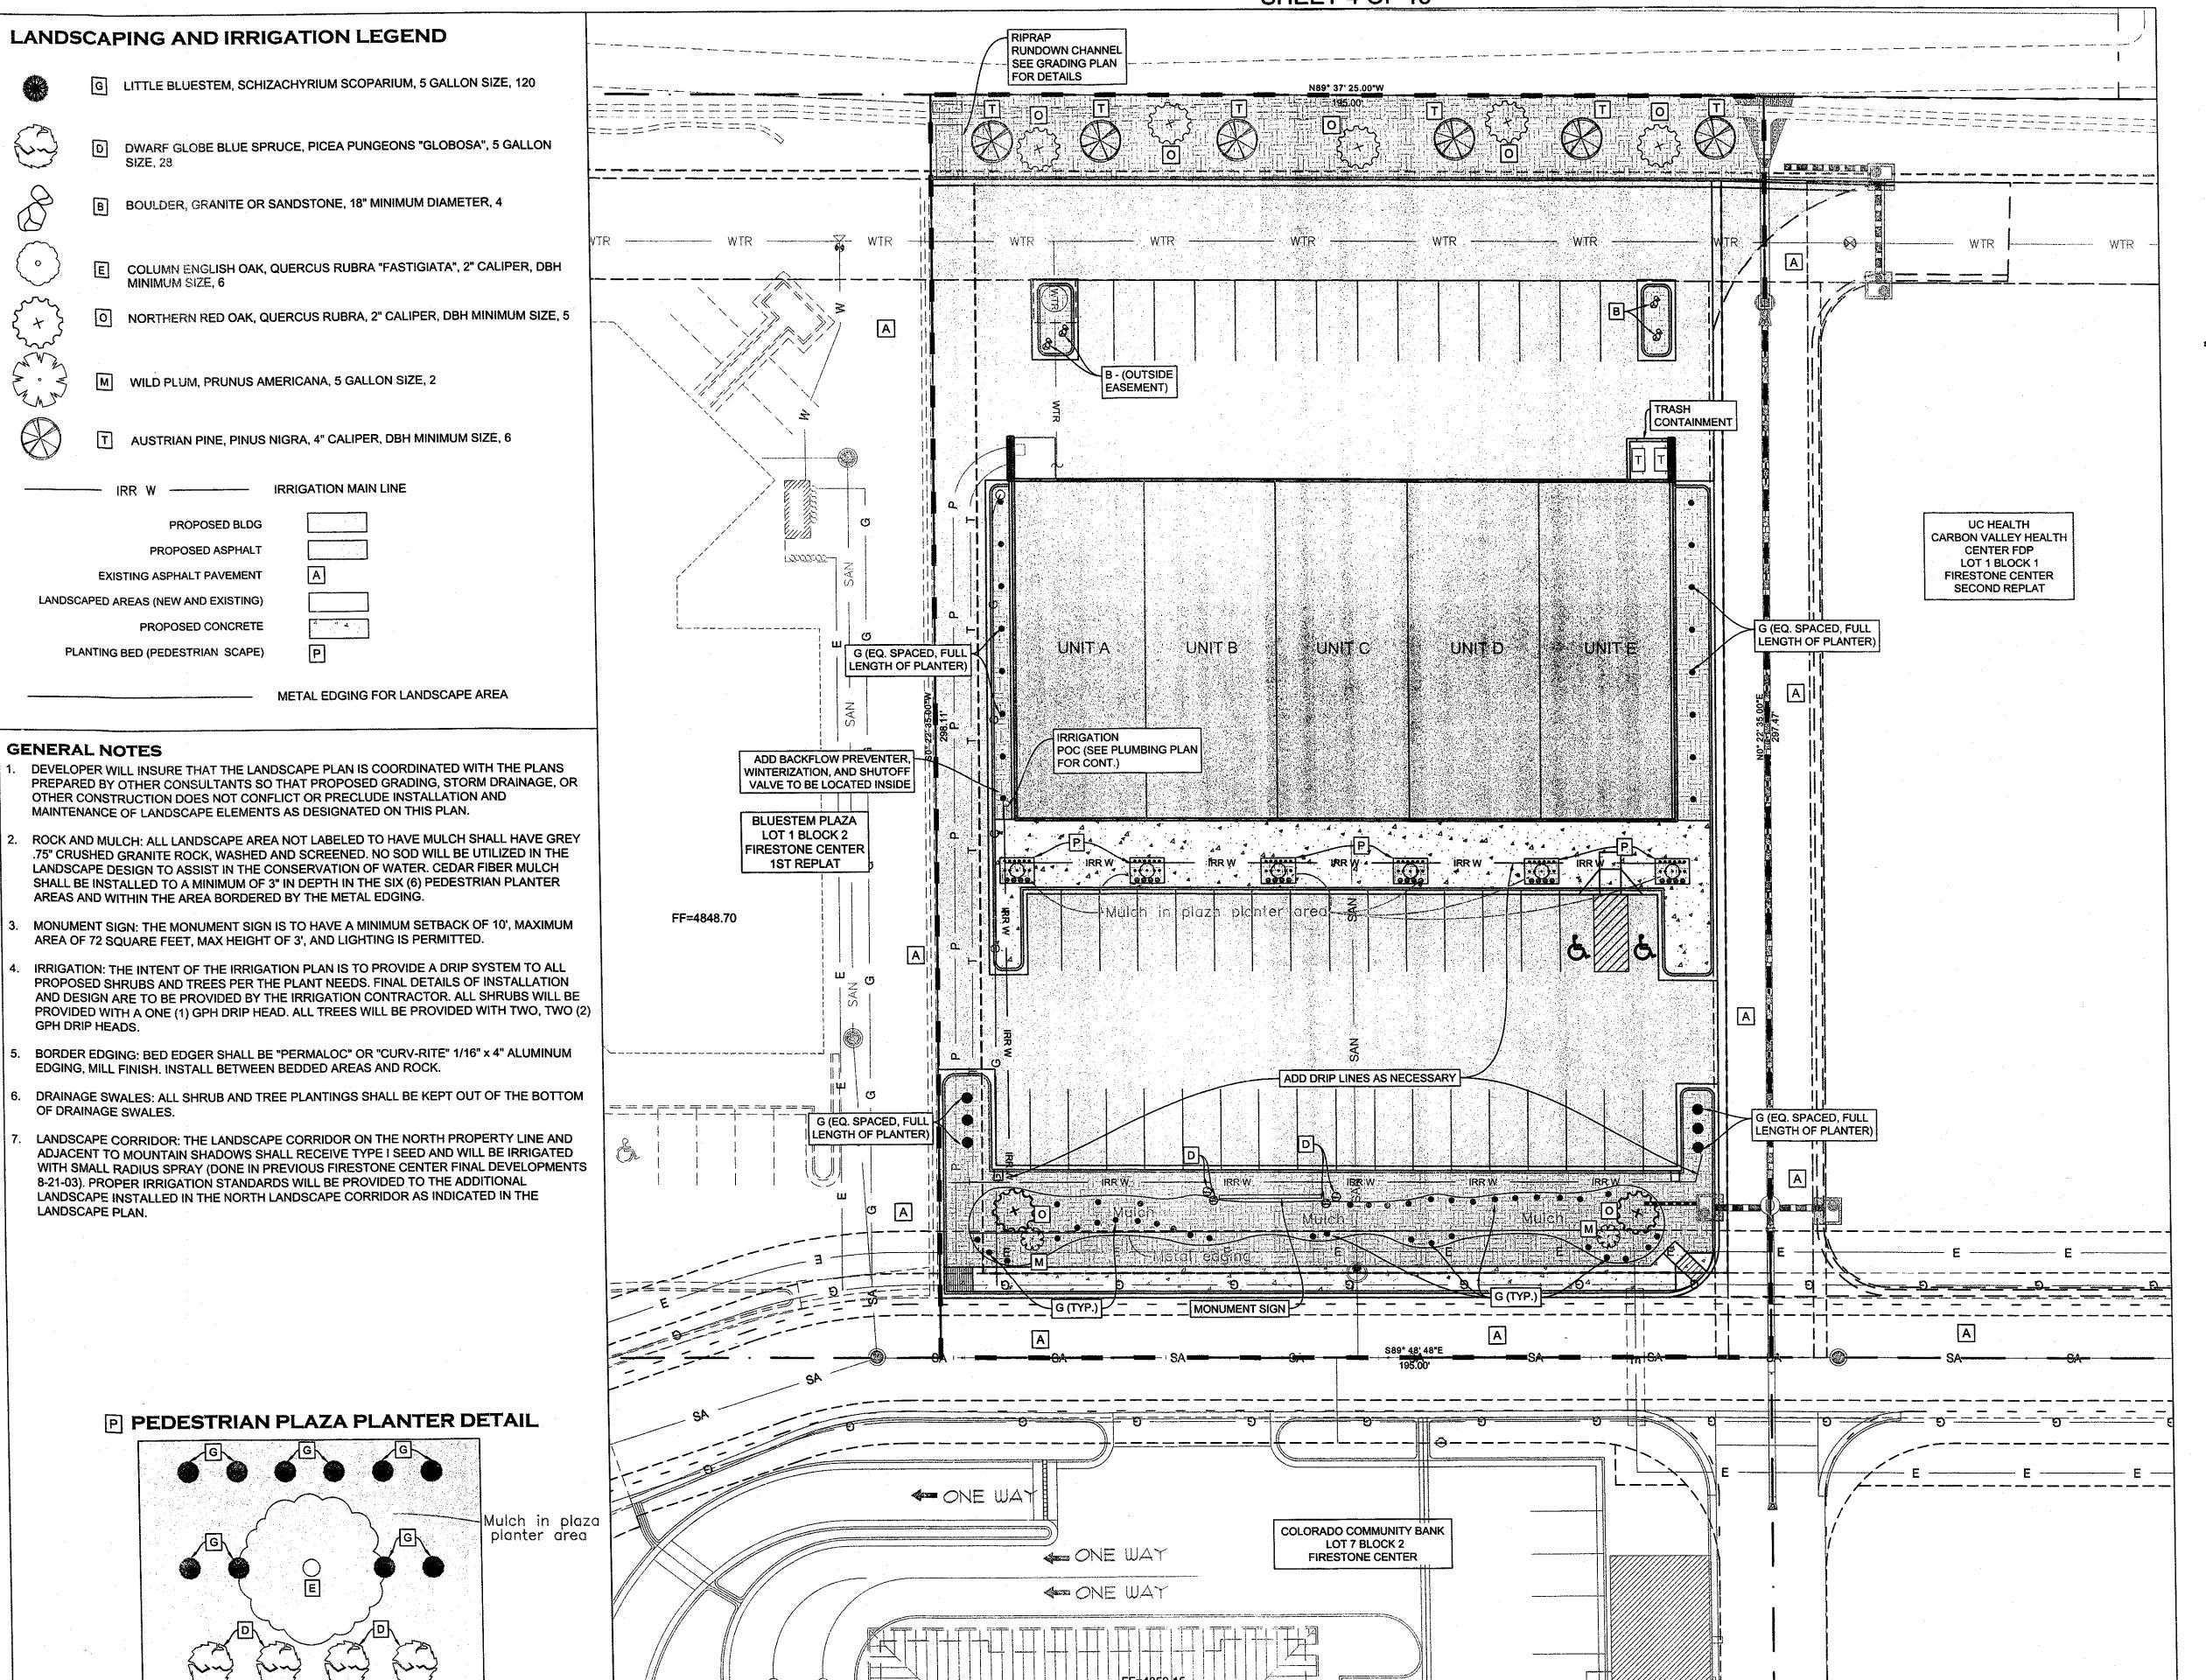

SMOOTH STONE BLASTED LETTERS


BLUESTEM TECH CENTER
11052 CIMARRON STREET

SEE SITE PLAN SHEET FOR LOCATION

MONUMENT SIGN DETAIL

24'-0"


1/4" = 1'-0"

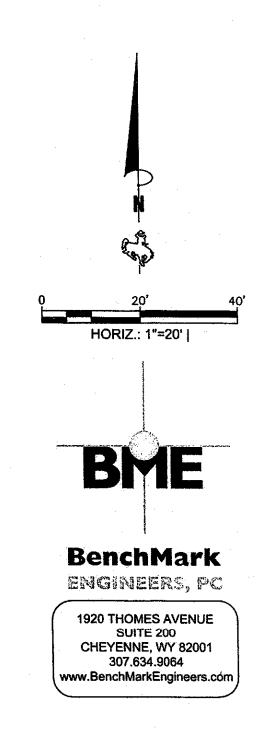

	NE INFORMATION BLOCK
L	ANDSCAPE PLAN
NAME OF SUBMITTAL:	BLUESTEM YECH CENTER
TYPE OF SUBMITTAL:	FINAL DEVELOPMENT PLAN
FILING NUMBER:	N/A
PHASE NUMBER:	N/A
PREPARATION DATE:	04/15/2016
REVISION DATE:	06/20/2016
REVISION DATE:	07/01/2016
REVISION DATE:	08/18/2016
REVISION DATE:	09/29/2016
REVISION DATE:	
	SHEET 4 OF 15

### BLUESTEM TECH CENTER


LANDSCAPE DETAILS TOWN OF FIRESTONE, WELD COUNTY, STATE OF COLORADO SHEET 5 OF 15

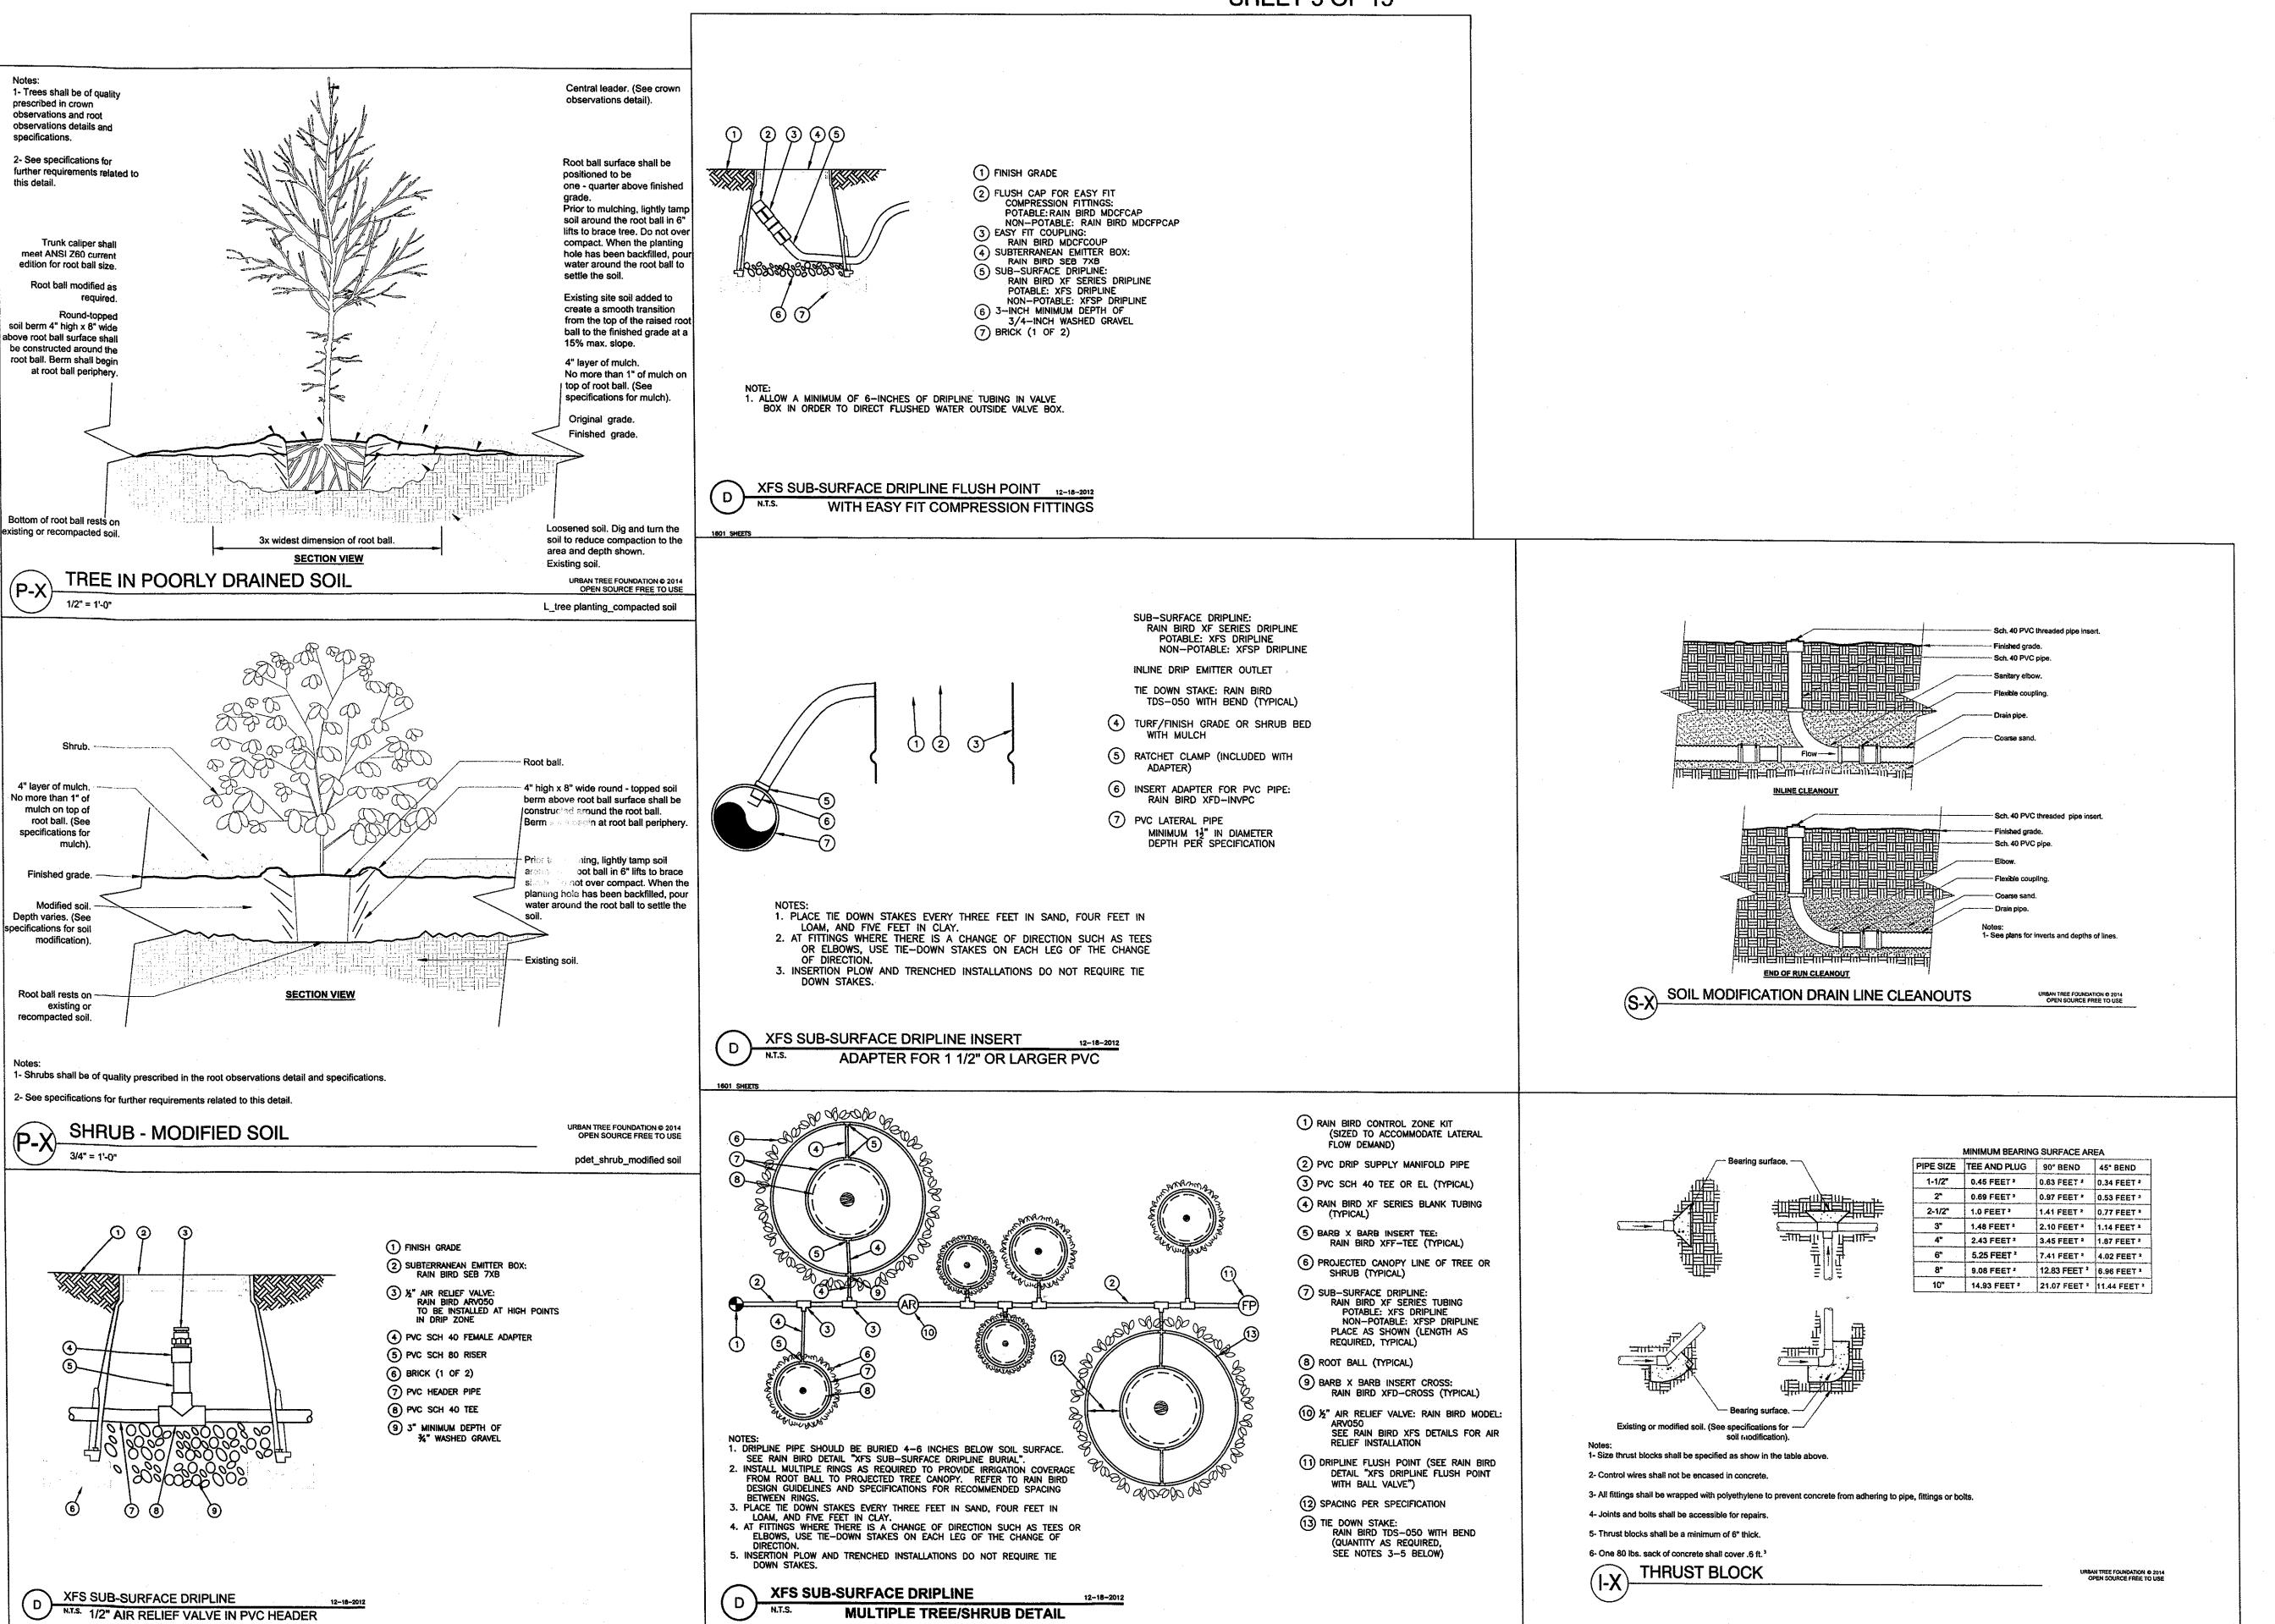

**MULTIPLE TREE/SHRUB DETAIL** 



HIRES I O	NE INFORMATION BLOCK
· L	ANDSCAPE DETAILS
AME OF SUBMITTAL:	BLUESTEM TECH CENTER
YPE OF SUBMITTAL:	FINAL DEVELOPMENT PLAN
ILING NUMBER:	N/A
HASE NUMBER:	N/A
REPARATION DATE:	04/15/2016
EVISION DATE:	06/20/2016
EVISION DATE:	07/01/2016
EVISION DATE:	08/18/2016
EVISION DATE:	09/29/2016
EVISION DATE:	
	SHEET 5 OF 15

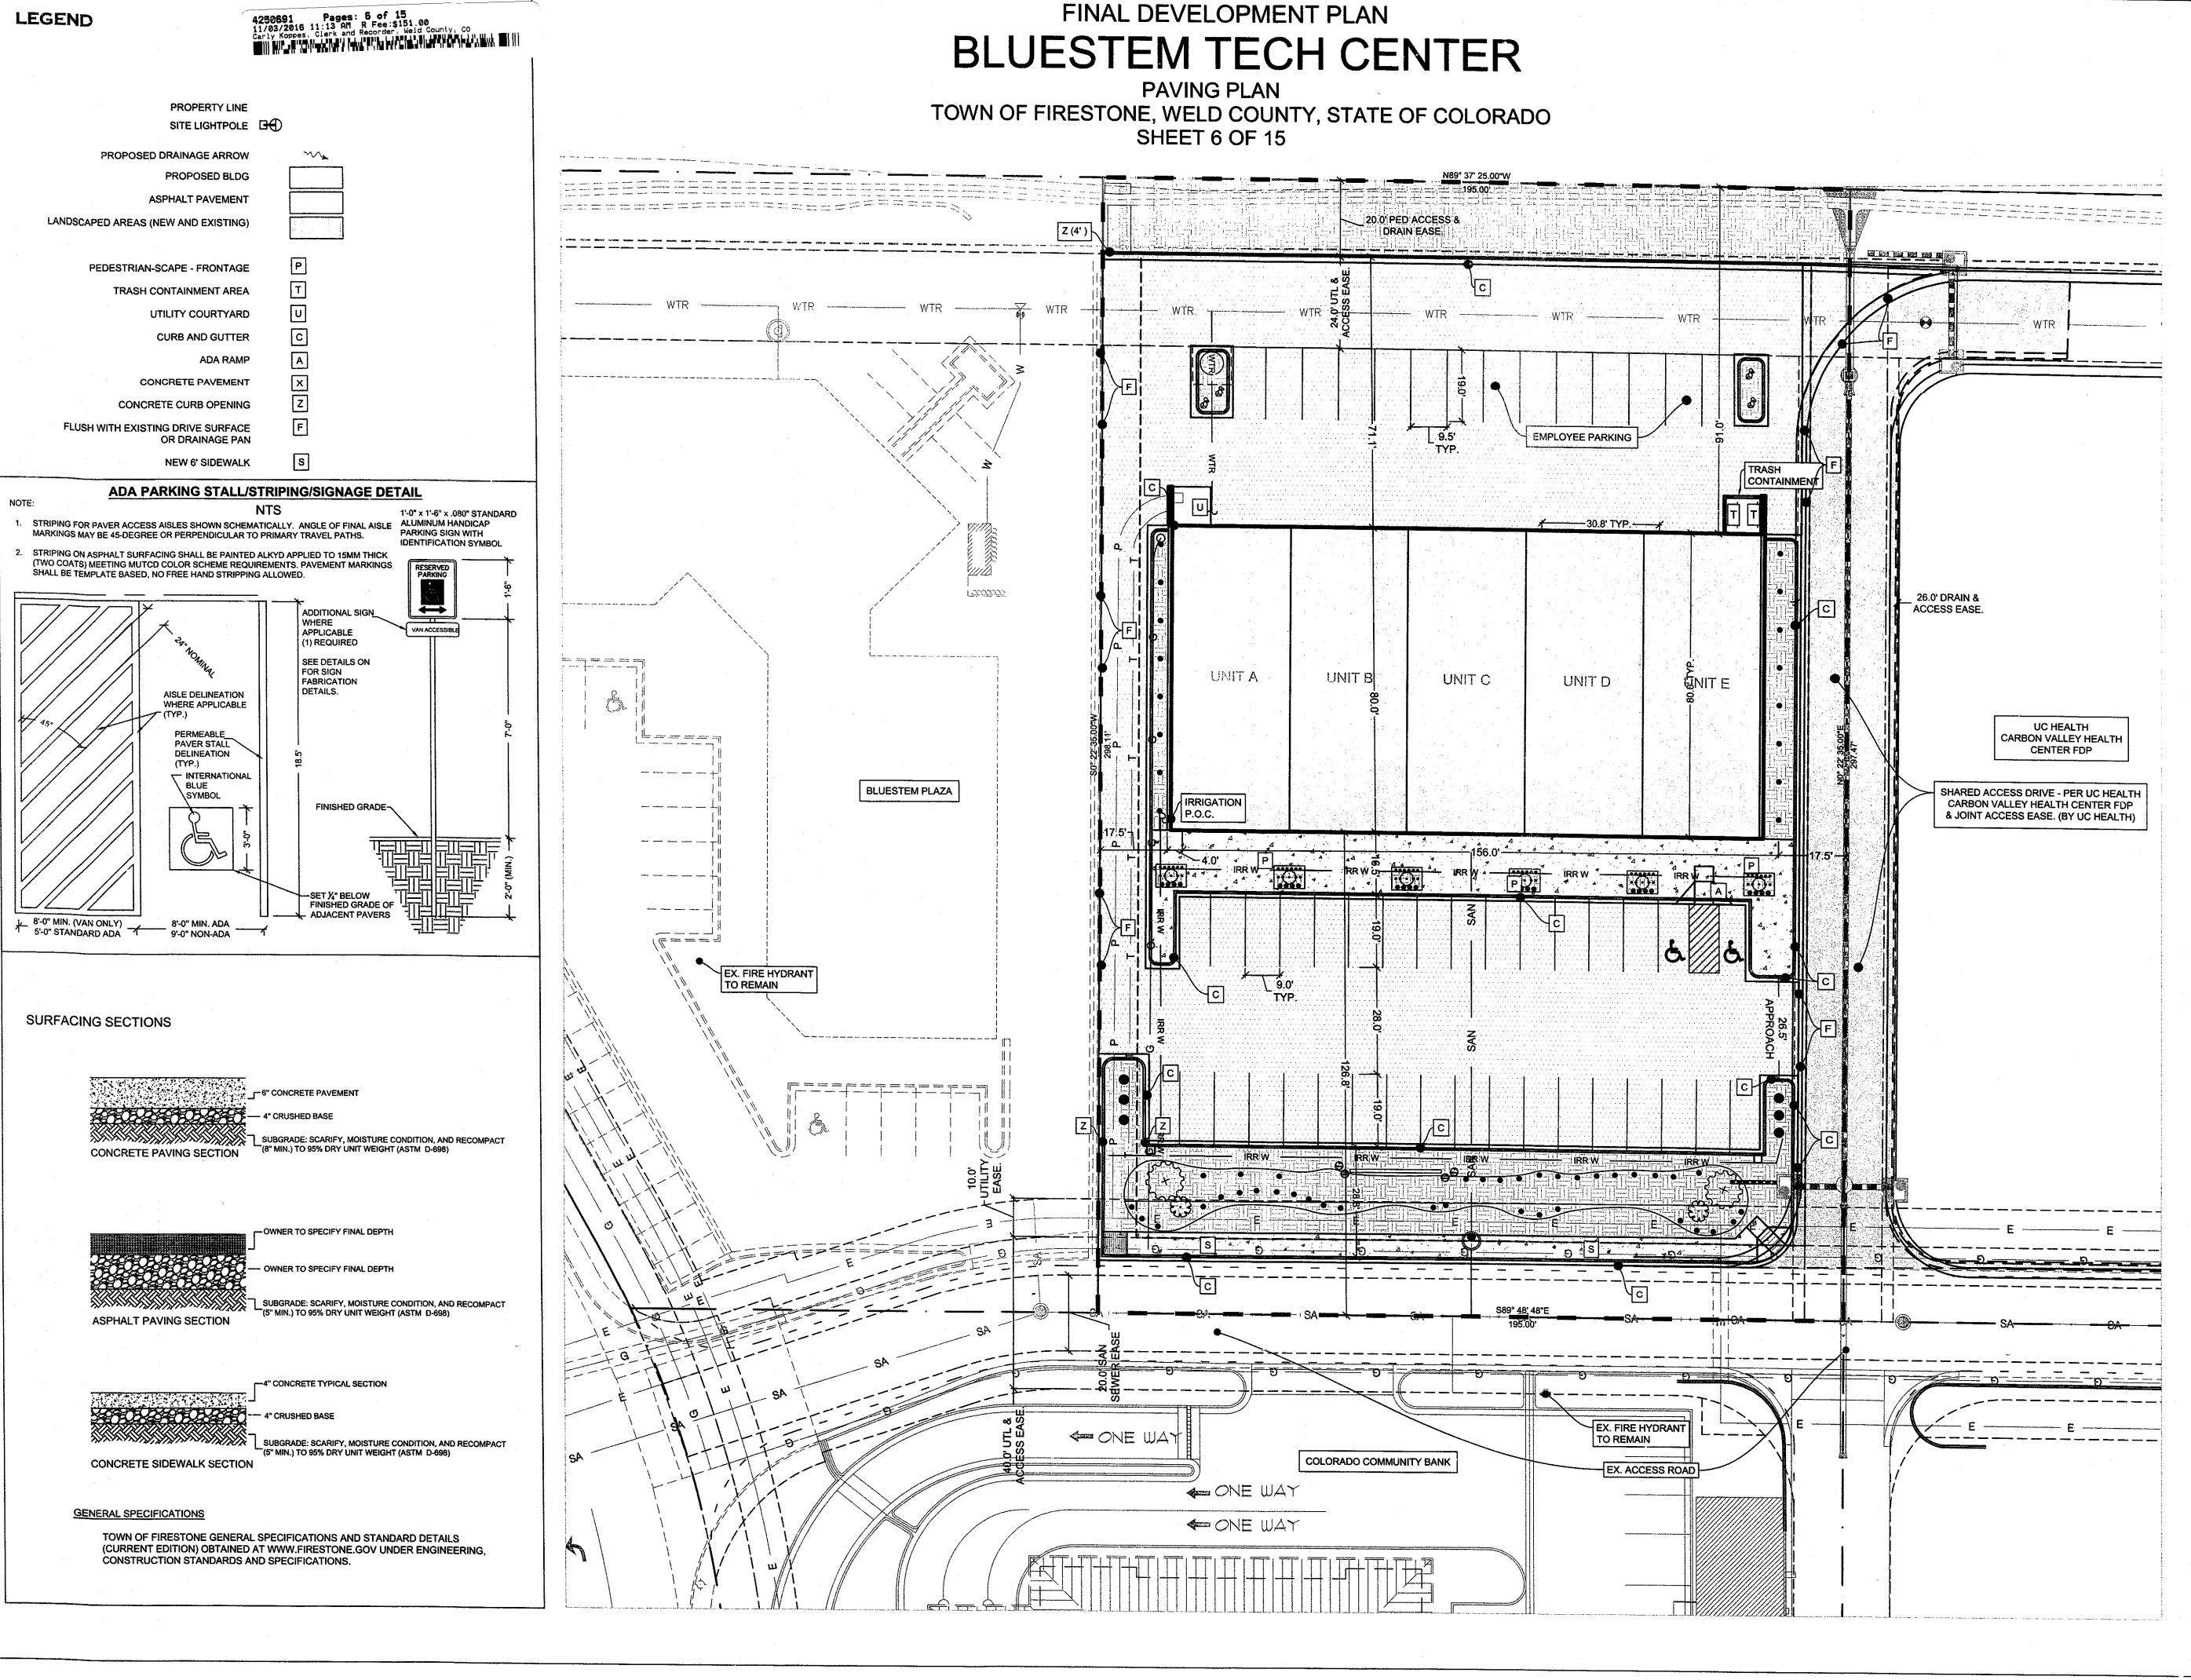






#### BenchMark ENGINEERS, PC


1920 THOMES AVENUE SUITE 200 CHEYENNE, WY 82001 307.634.9064 www.BenchMarkEngineers.com

FIRESTO	NE INFORMATION BLOCK
P	'AVING PLAN
NAME OF SUBMITTAL:	BLUESTEM TECH CENTER
TYPE OF SUBMITTAL:	FINAL DEVELOPMENT PLAN
FILING NUMBER:	N/A
PHASE NUMBER:	N/A
PREPARATION DATE:	04/15/2016
REVISION DATE:	06/20/2016
REVISION DATE:	07/01/2016
REVISION DATE:	08/18/2016
REVISION DATE:	09/29/2016
REVISION DATE:	
	SHEET 6 OF 15

# BLUESTEM TECH CENTER

**UTILITY PLAN** TOWN OF FIRESTONE, WELD COUNTY, STATE OF COLORADO

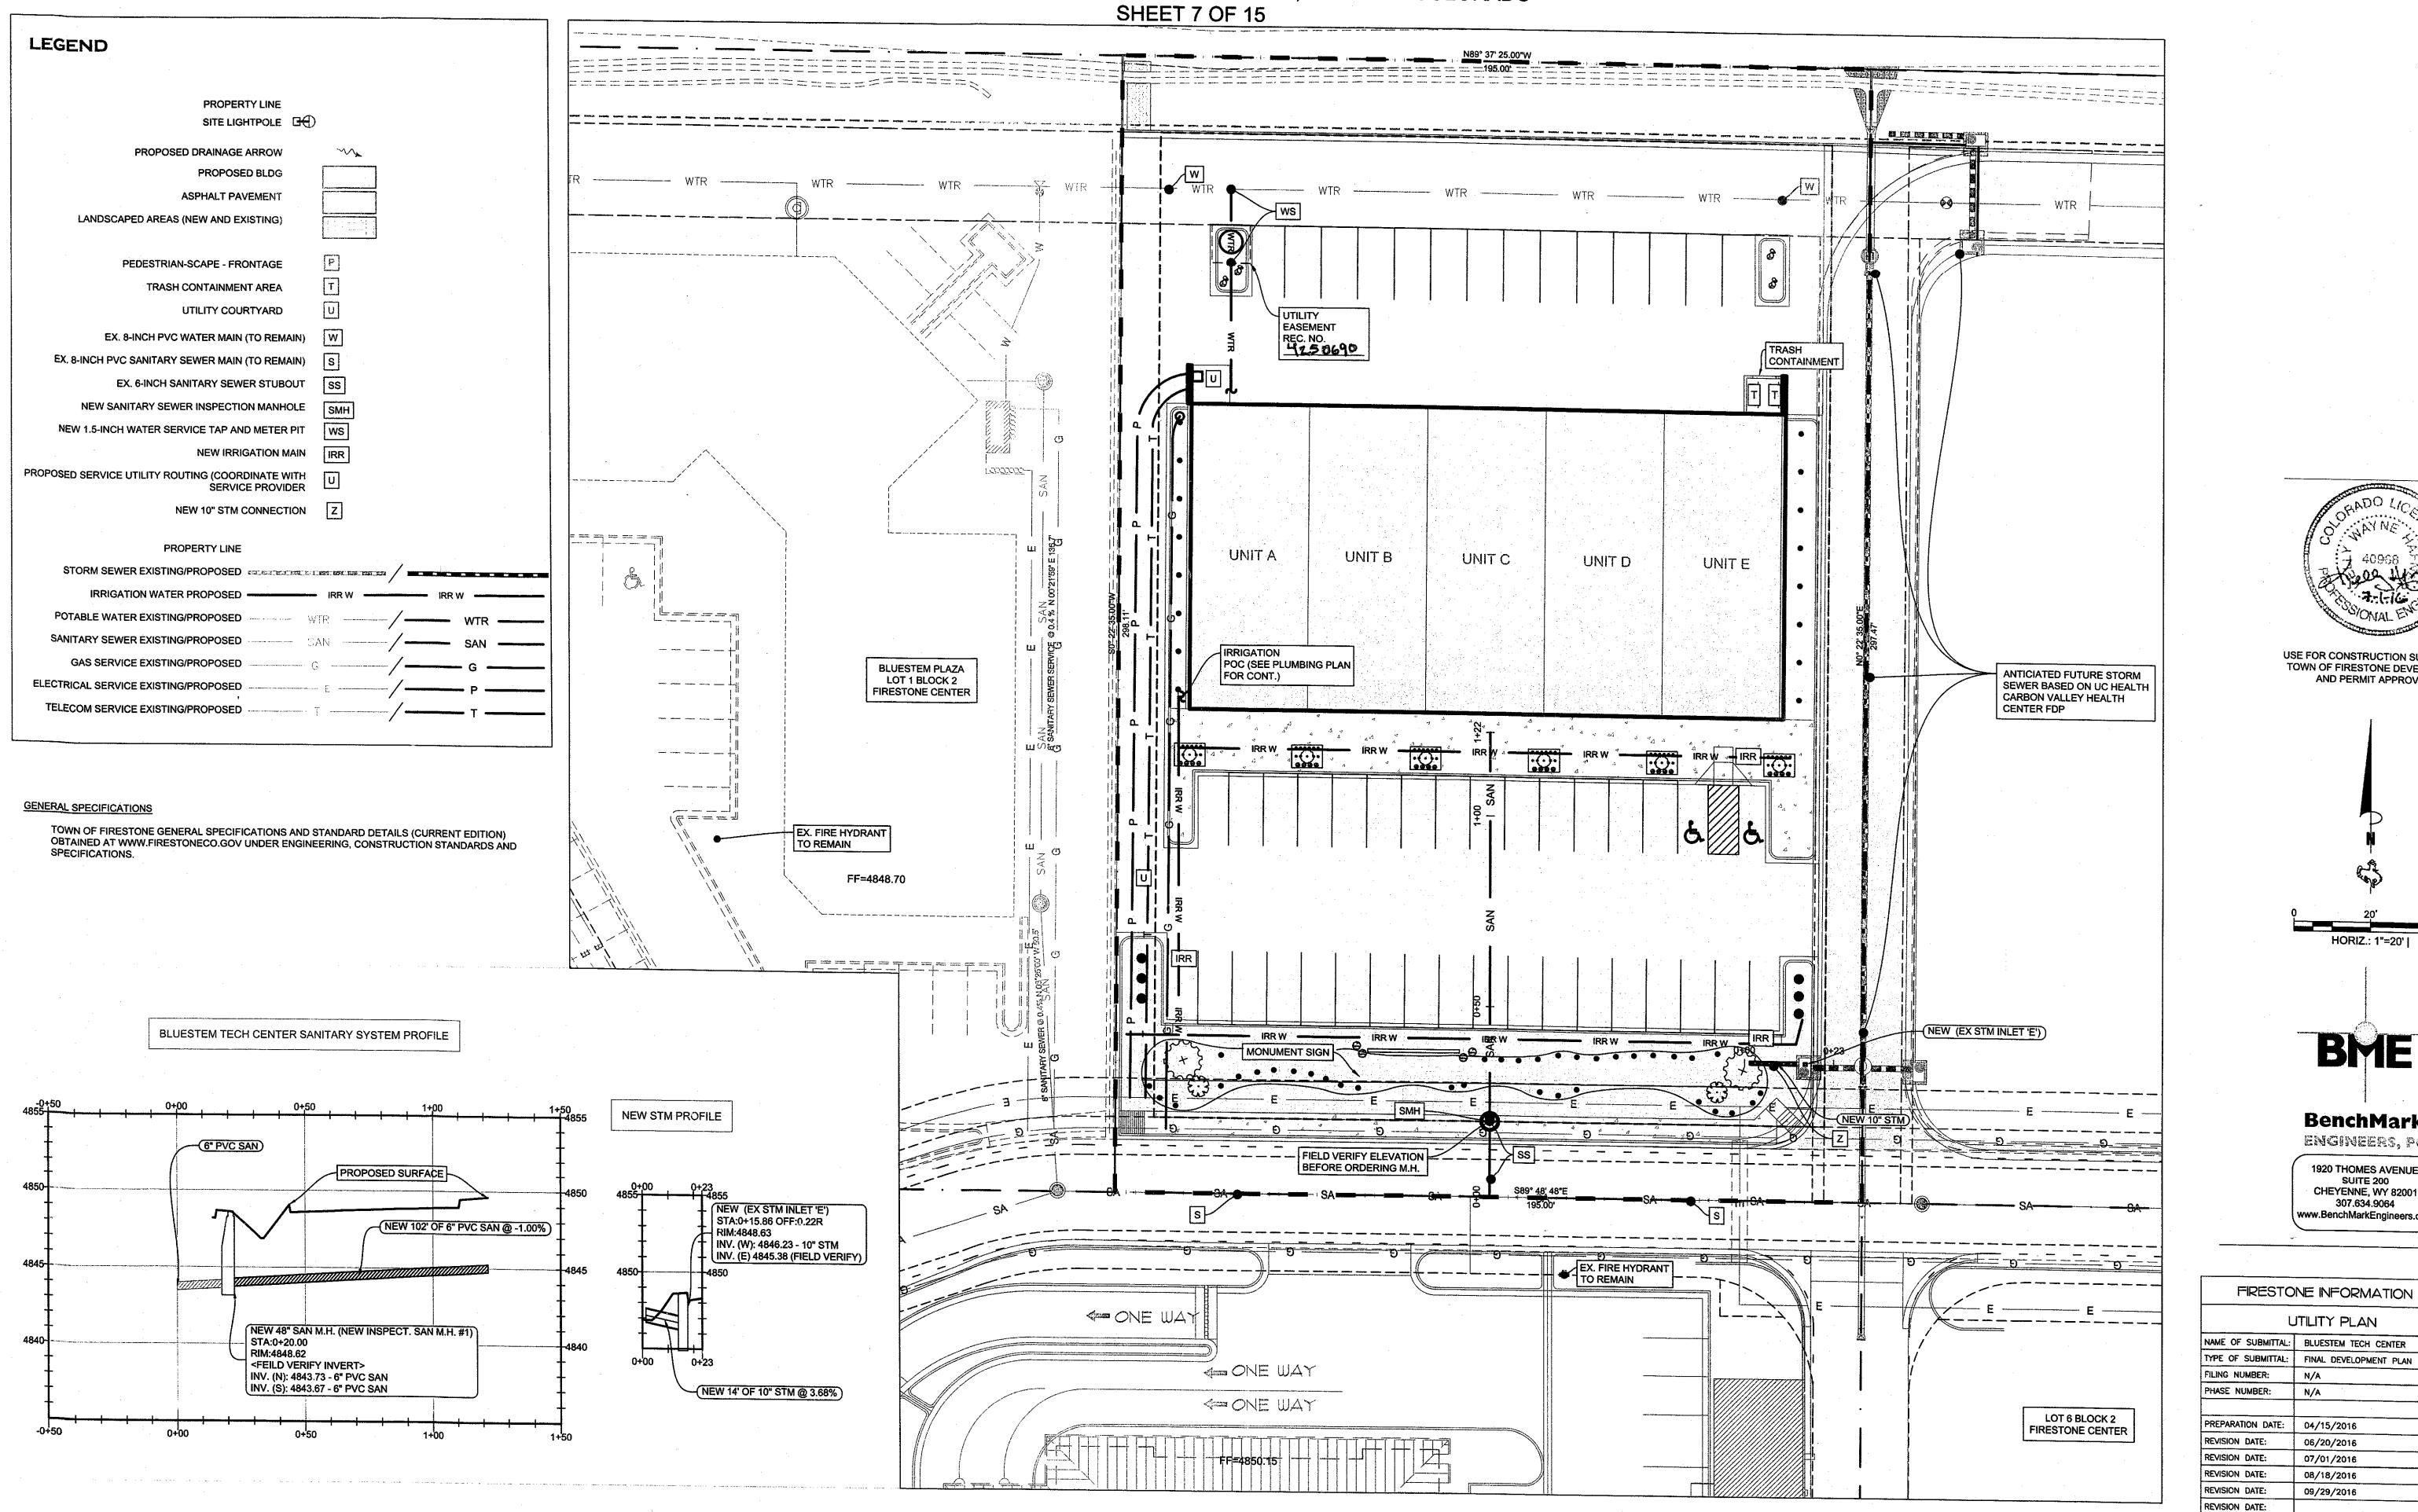

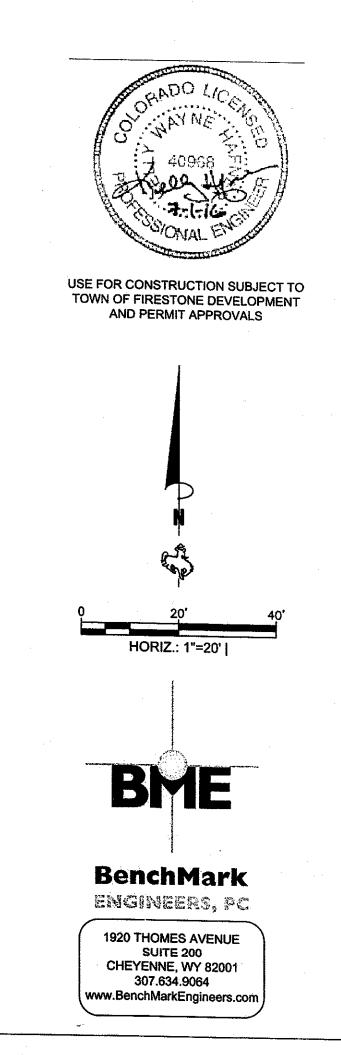

FIRESTONE INFORMATION BLOCK

UTILITY PLAN

06/20/2016 07/01/2016

08/18/2016

09/29/2016

SHEET 7 OF 15

#### GENERAL SPECIFICATIONS


TOWN OF FIRESTONE GENERAL SPECIFICATIONS AND STANDARD DETAILS (CURRENT EDITION) OBTAINED AT WWW.FIRESTONE.GOV UNDER ENGINEERING, CONSTRUCTION STANDARDS AND SPECIFICATIONS.


#### FINAL DEVELOPMENT PLAN


### BLUESTEM TECH CENTER


UTILITY DETAIL


TOWN OF FIRESTONE, WELD COUNTY, STATE OF COLORADO SHEET 8 OF 15

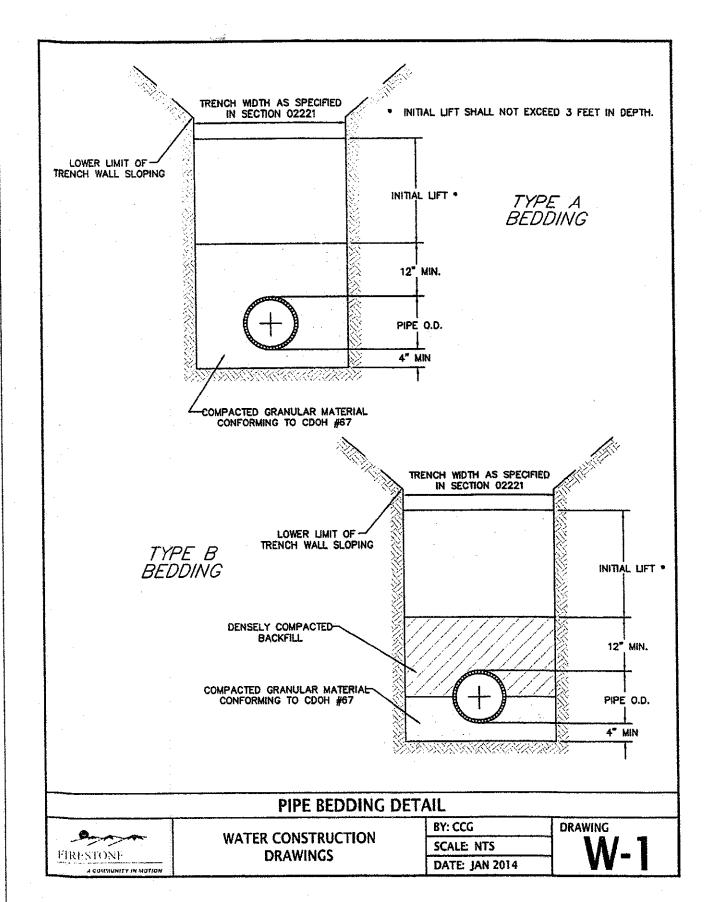


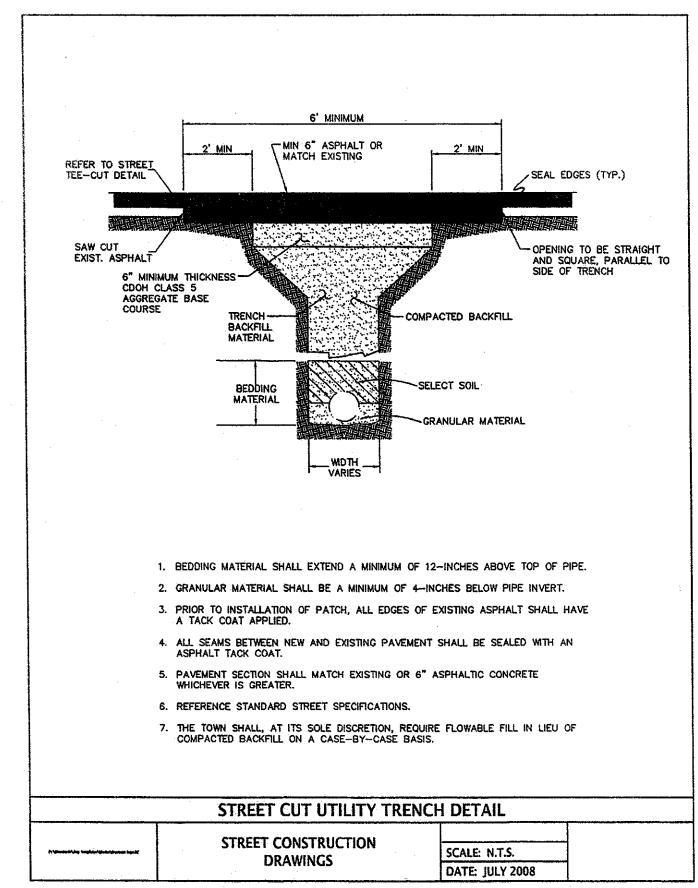


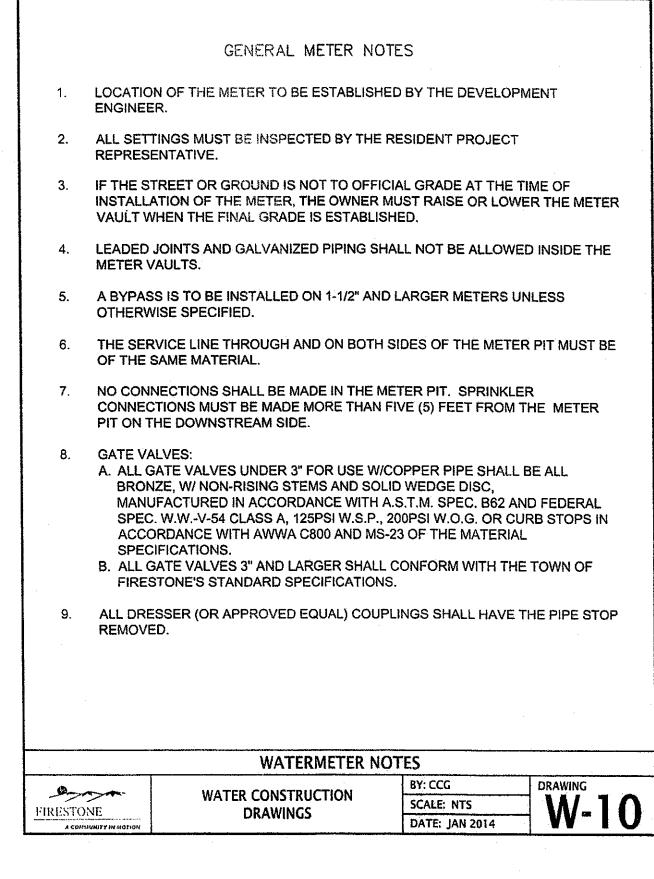


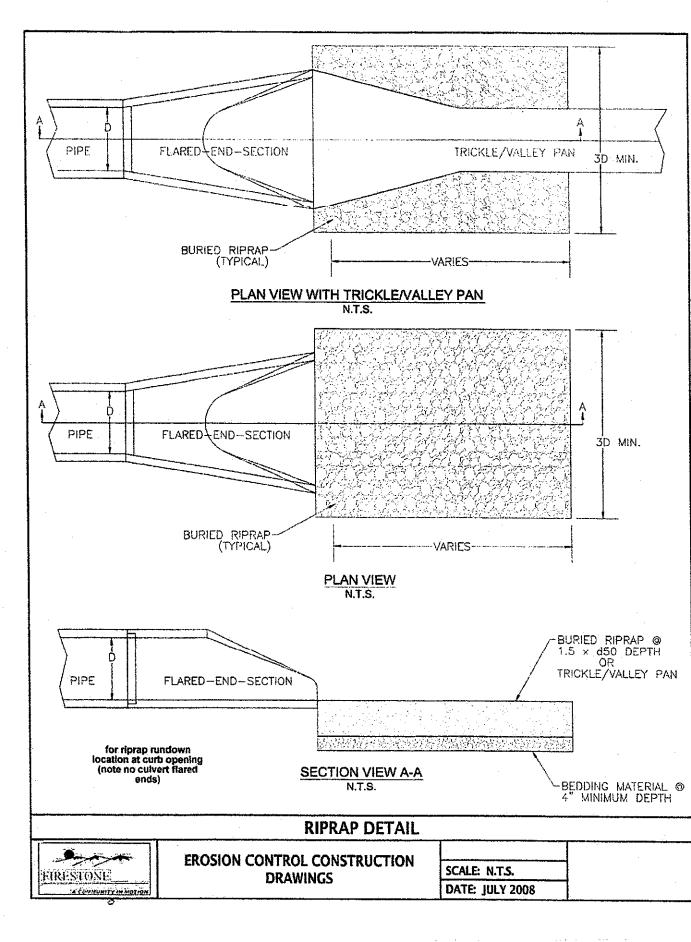

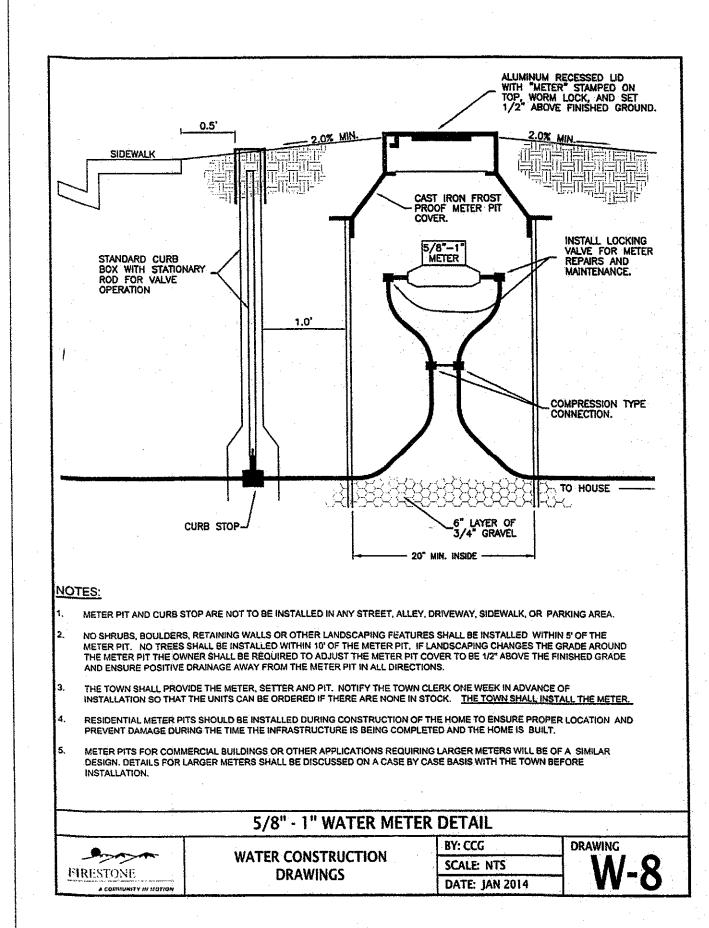


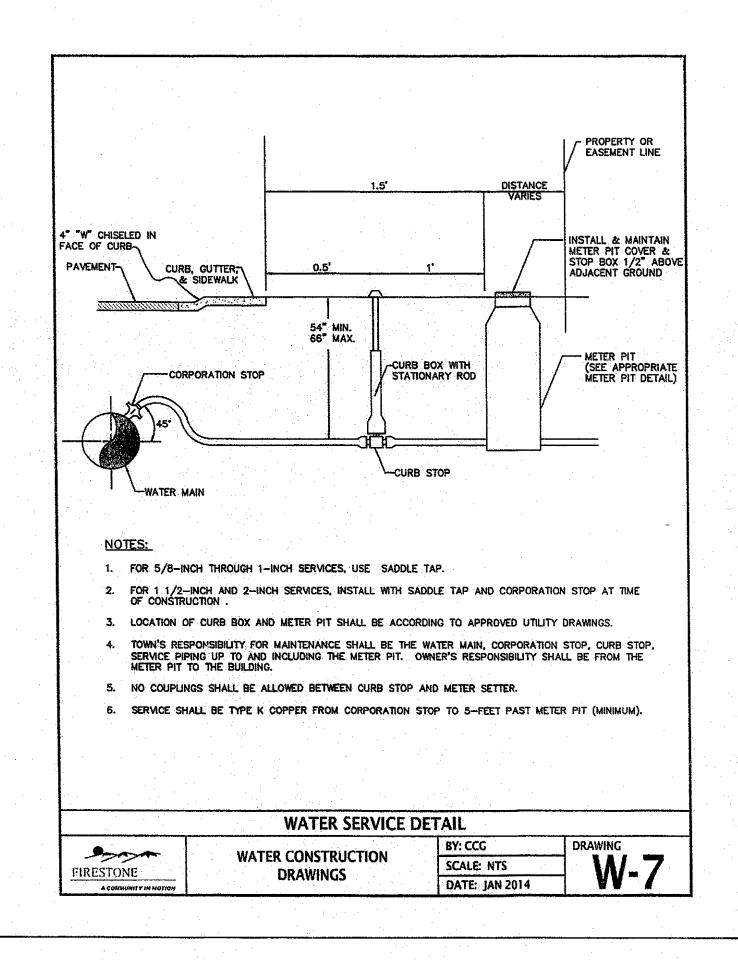

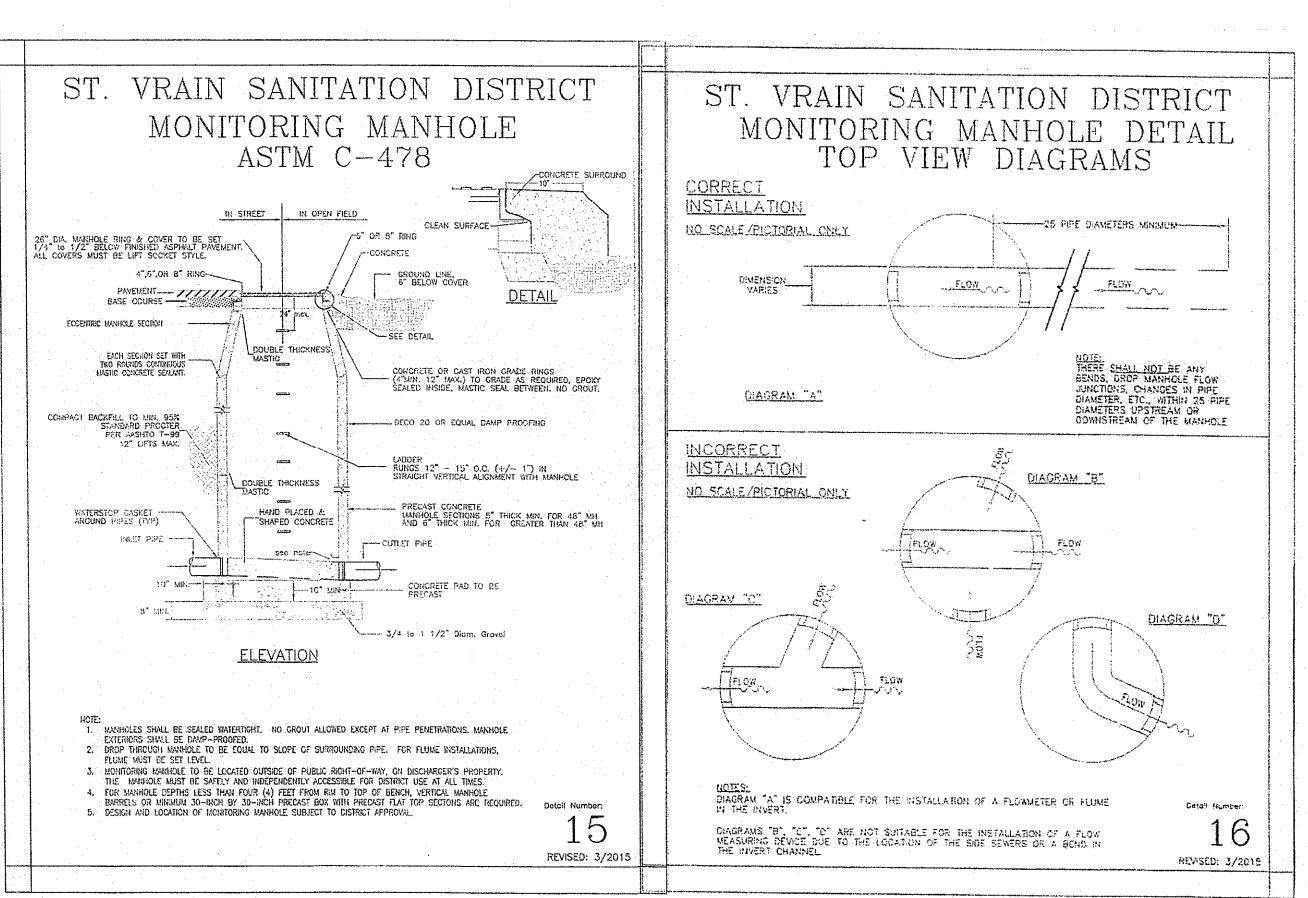

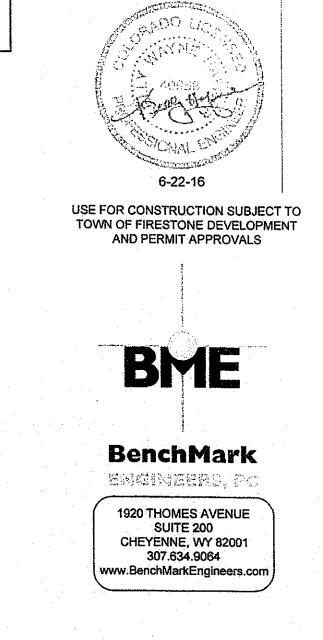

FIRESTO	NE INFORMATION BLOCK	
	UTILITY DETAIL	
NAME OF SUBMITTAL: BLUESTEM TECH CENTER		
TYPE OF SUBMITTAL:	FINAL DEVELOPMENT PLAN	
FILING NUMBER:	N/A	
PHASE NUMBER:	N/A	
PREPARATION DATE:	04/15/2016	
REVISION DATE:	06/20/2016	
REVISION DATE:	07/01/2016	
REVISION DATE:	08/18/2016	
REVISION DATE:	09/29/2016	
REVISION DATE:		
	SHEET 8 OF 15	

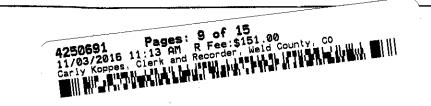

TYPE C CONSTRUCTION

DOWEL SPACING FOR TYPE


TRANSVERSE JOINT


### FINAL DEVELOPMENT PLAN


### BLUESTEM TECH CENTER


SITE DETAIL

TOWN OF FIRESTONE, WELD COUNTY, STATE OF COLORADO SHEET 9 OF 15

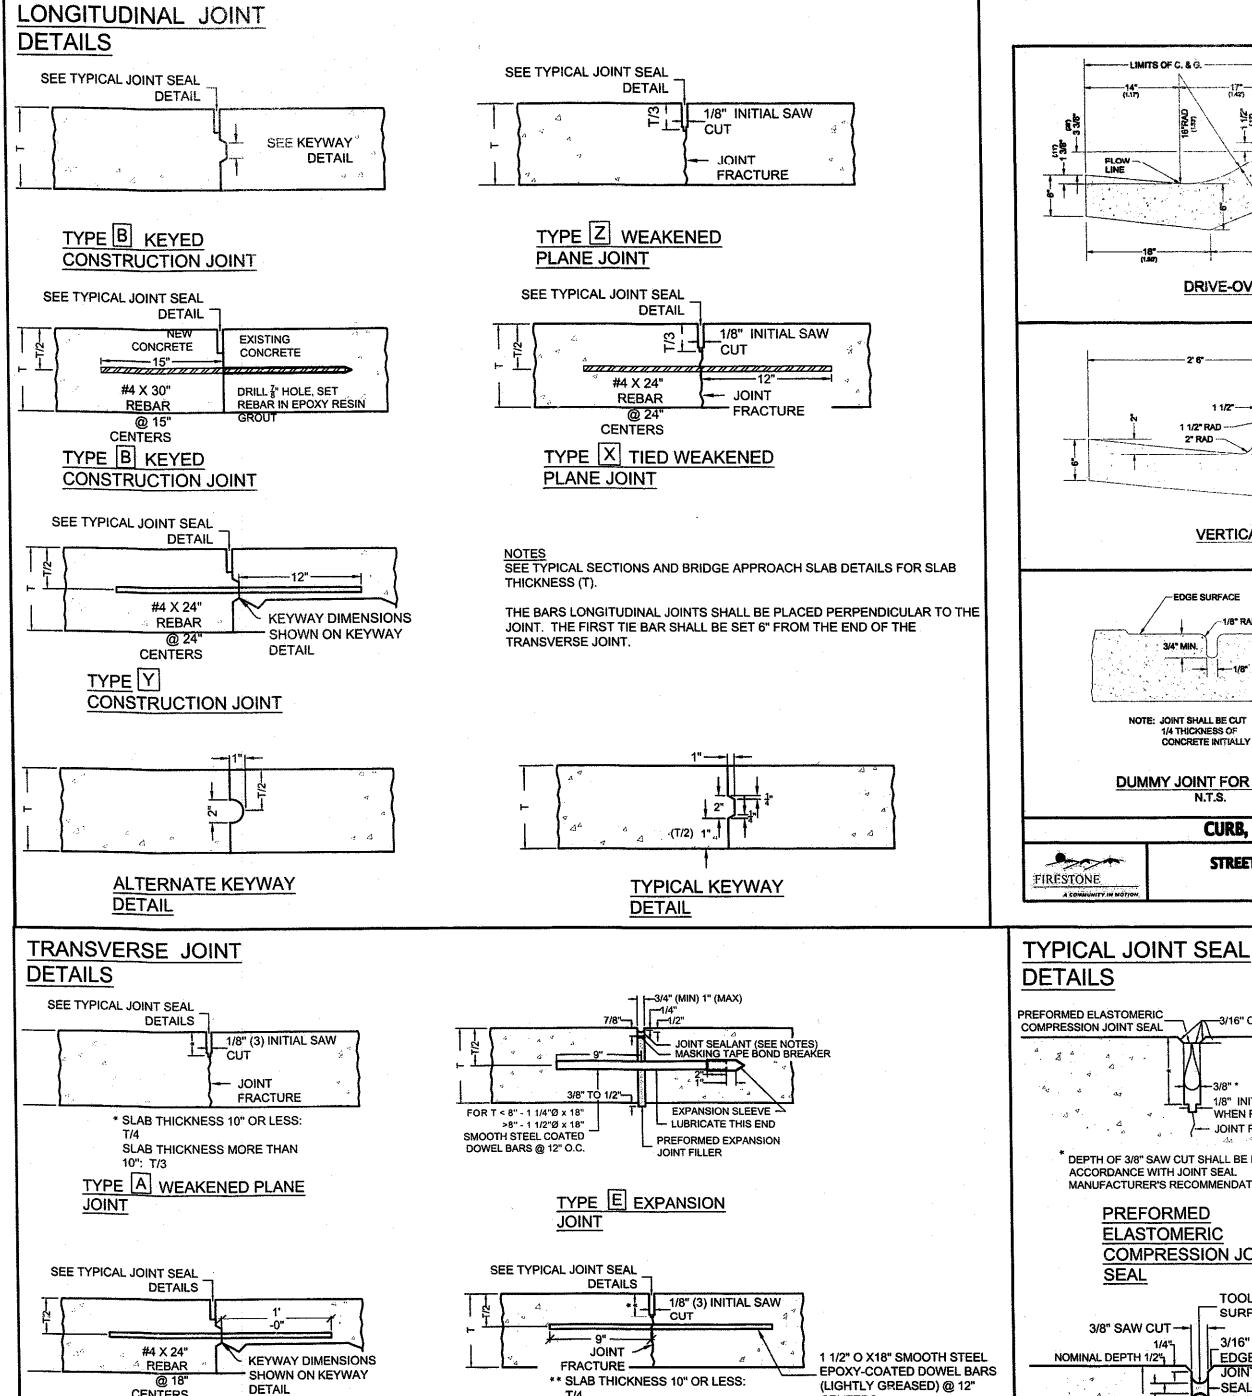

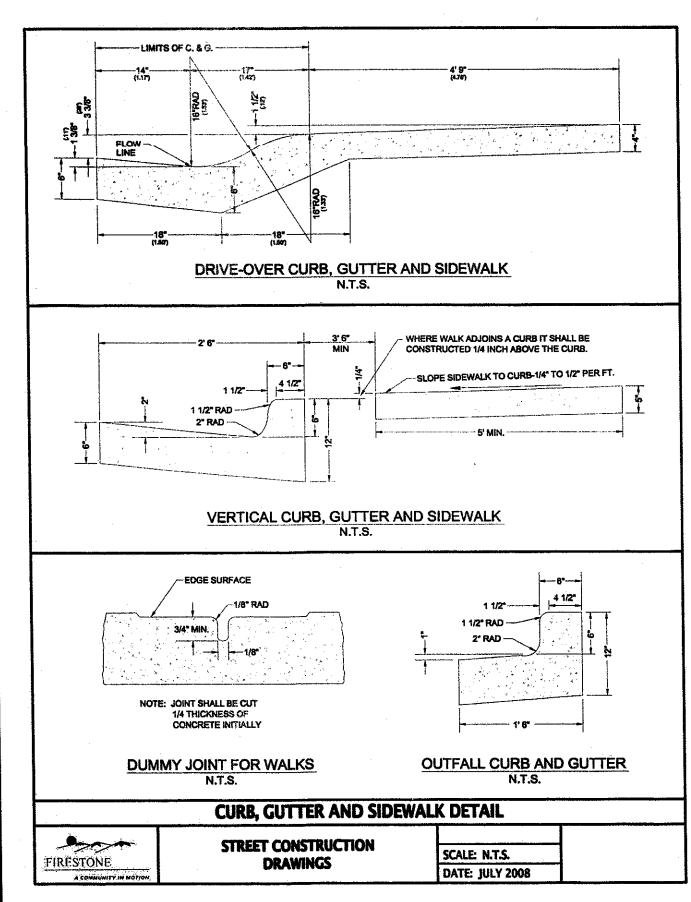

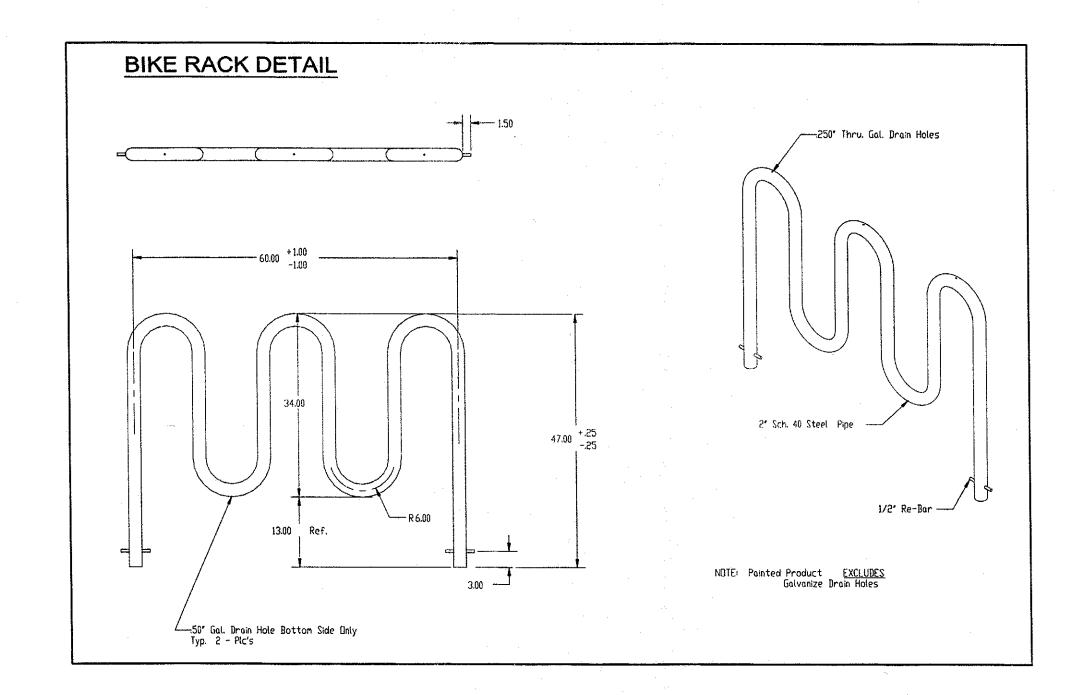

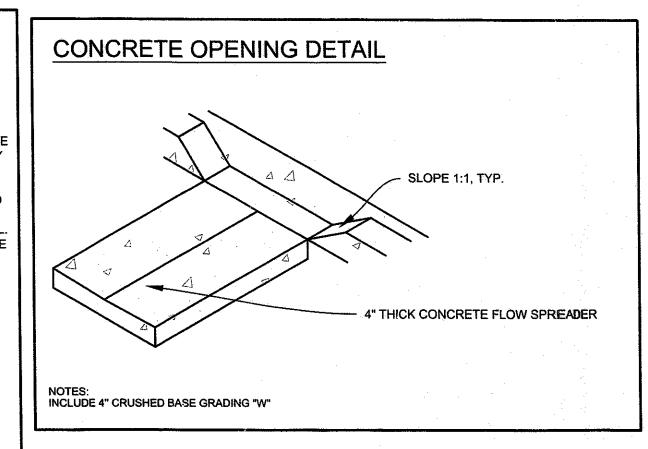



SPECIFICATIONS AND STANDARD DETAILS (CURRENT EDITION) OBTAINED AT WWW.FIRESTONECO.GOV UNDER ENGINEERING, CONSTRUCTION STANDARDS AND SPECIFICATIONS.




USE FOR CONSTRUCTION SUBJECT TO TOWN OF FIRESTONE DEVELOPMENT AND PERMIT APPROVALS




307.634.9064

www.BenchMarkEngineers.con

FIRESTO	NE INFORMATION BLOCK
	SITE DETAIL
NAME OF SUBMITTAL:	BLUESTEM TECH CENTER
TYPE OF SUBMITTAL:	FINAL DEVELOPMENT PLAN
FILING NUMBER:	N/A
PHASE NUMBER:	N/A
PREPARATION DATE:	04/15/2016
REVISION DATE:	06/20/2016
REVISION DATE:	07/01/2016
REVISION DATE:	08/18/2016
REVISION DATE:	09/29/2016
REVISION DATE:	
	SHEET 9 OF 15

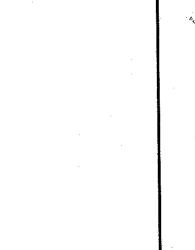

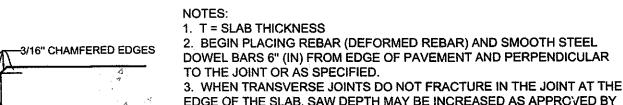


EDGE OF THE SLAB, SAW DEPTH MAY BE INCREASED AS APPROVED BY THE ENGINEER AT NO ADDITIONAL COST TO THE OWNER. 4. SEAL TYPE "E" JOINT WITH SILICONE SEAL. 5. SEAL REMAINING TYPES OF TRANSVERSE JOINTS WITH PREFORMED ELESOMERIC COMPRESSION JOINTS SEALS.

6. SEAL LONGITUDINAL JOINTS WITH HOT POURED ELASTIC JOINT SEAL. 7. SEAL JOINTS WITH SILICONE SEALANT ONLY WHEN SPECIFIED IN THE 8. TAPE OR CLOSE JOINT ENDS AS APPROVED BY THE ENGINEER TO

PREVENT LOSS OF JOINT SEALANT.

JOINT DIMENSIONS (SILICONE SEALANT)				
ORIGINAL SAW CUT	"A" WIDTH OF SAW CUT	"B" DEPTH OF SAWCUT	"C" SEALANT THICKNESS	"D" BACKER ROD DIAMETER
INCHES	INCHES	INCHES	INCHES	INCHES
LESS THAN 3/8	3/8	1 1/2	1/4	1/2
3/8	1/2	1 1/2	1/4	5/8
1/2	5/8	1 3/4	5/16	3/4
5/8	3/4	2	3/8	1
3/4	7/8	2	7/16	1
7/8	1	2 1/4	1/2	1 1/4
FROM 1 TO 2	ORIGINAL WIDTH PLUS 1/8	DIM. "A" PLUS 1 1/2	1/2	DIM. "A" PLUS 1/8

TOOLED SURFACE 3/16" CHAMFERED EDGES SEALANT
"D" Ø BACKER 一片 1/8" INITIAL SAW JOINT FRACTURE SILICONE SEALANT

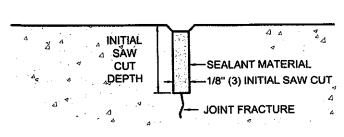

ROD

1/8" INITIAL SAW CUT

WHEN REQUIRED

- JOINT FRACTURE

DEPTH OF 3/8" SAW CUT SHALL BE IN ACCORDANCE WITH JOINT SEAL

**PREFORMED** 

3/8" SAW CUT--

**ELASTOMERIC** 

MANUFACTURER'S RECOMMENDATIONS.

**COMPRESSION JOINT** 

IF TRANSVERSE JOINTS DO NOT FRACTURE AT THE JOINT ON THE OUTER EDGES OF THE SLAB, THE ENGINEER MAY DIRECT THAT THE SAW CUT DEPTH BE INCREASED FOR NO ADDITIONAL PAYMENT.

NOTES
SEE TYPICAL SECTIONS AND BRIDGE APPROACH SLAB DETAILS FOR SLAB

THE BARS (DEFORMED REBAR) SHALL BE PLACED PERPENDICULAR TO THE JOINT. THE FIRST TIE BAR SHALL BE SET 6 INCHES FROM THE END OF

SMOOTH DOWEL BARS SHALL BE PLACED PARALLEL TO THE DIRECTION

THE FIRST DOWEL SHALL BE PLACED 6 INCHES FROM THE END OF THE

SLAB THICKNESS MORE THAN

TYPE D TRANSVERSE DOWELED

WEAKENED PLANE JOINT

THE JOINT, UNLESS OTHERWISE SHOWN.

JOINT, UNLESS OTHERWISE SHOWN.

EDGE OF TRAVELED


CENTERS

HOT POURED ELASTIC JOINT



### BLUESTEM TECH CENTER

ADDRESS AND TRAFFIC CONTROL PLAN TOWN OF FIRESTONE, WELD COUNTY, STATE OF COLORADO 11052 CIMARRON STREET SHEET 10 OF 15

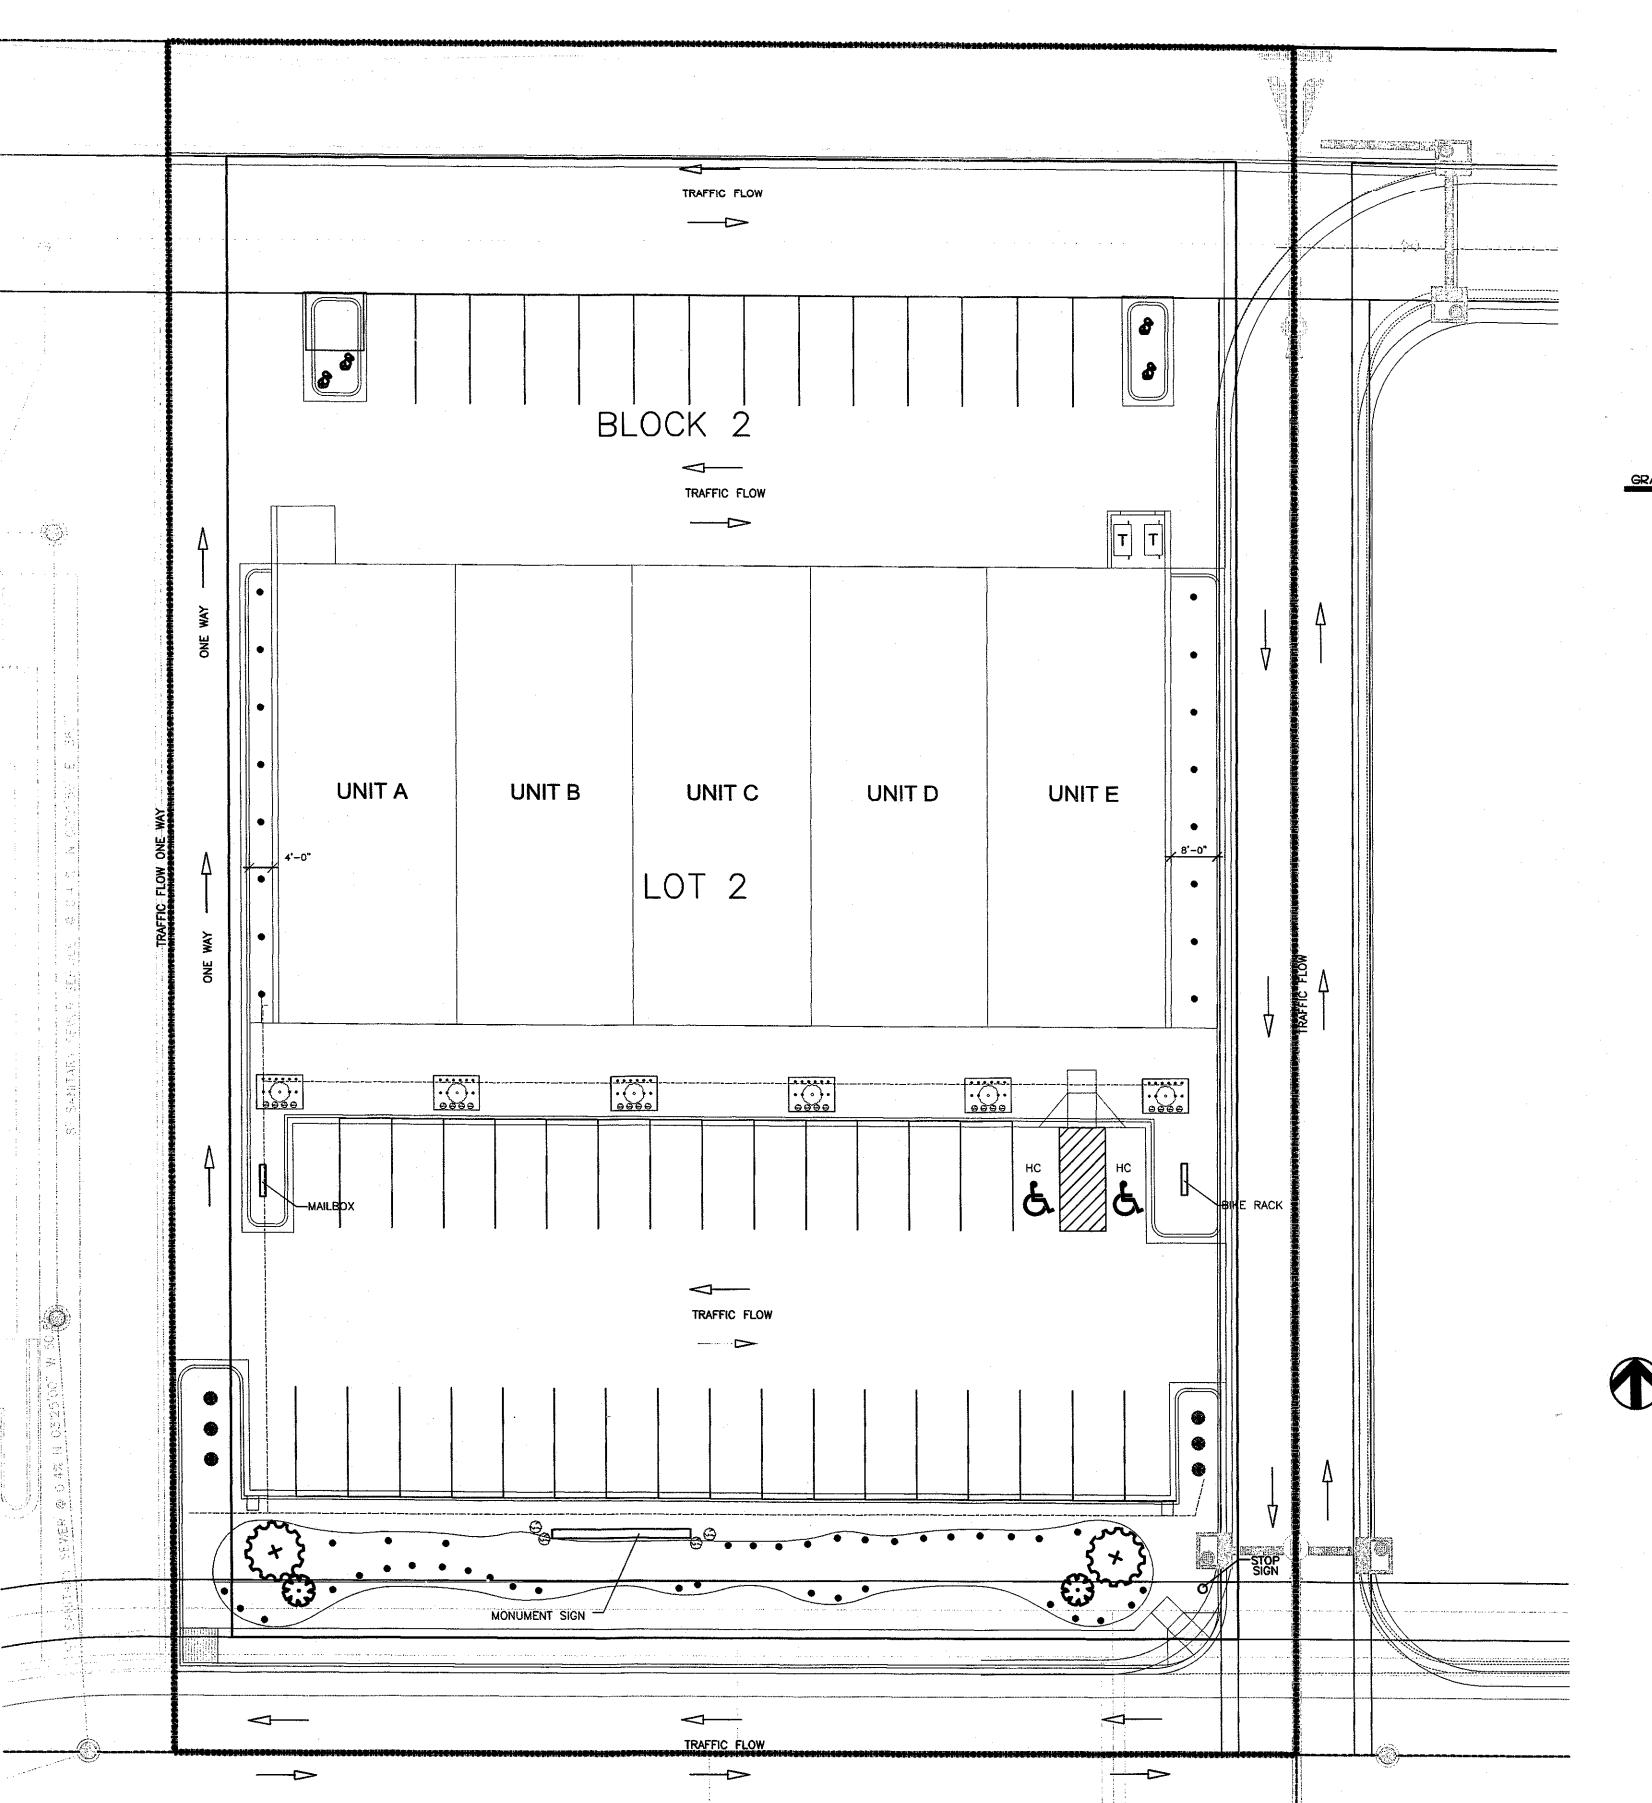

TENANT SIGNAGE

SINGLE PAN-CHANNEL LIGHTED LETTERS- REFER TO TITLE PAGE SIGNAGE AND SPECIFIC SIGN CRITERIA

TENANT SIGN DETAIL

1/4" = 1'-0"

SMOOTH STONE BLASTED LETTERS

BLUESTEM TECH CENTER
11052 CIMARRON STREET

SEE SITE PLAN SHEET FOR LOCATION

MONUMENT SIGN DETAIL

1/4" = 1'-0"

ALL UNITS WILL HAVE THE I I O52 CIMARRON STREET AND A LETTER DESIGNATION.

UNIT A UNIT B UNIT C UNIT D UNIT E

ADDRESS AND TRAFFIC CONTROL PLAN
SCALE: 1"=20"

TIRLOTO	NE INFORMATION BLOCK
ADDRESS	E TRAFFIC CONTROL PLAN
NAME OF SUBMITTAL:	BLUESTEM TECH CENTER
TYPE OF SUBMITTAL:	FINAL DEVELOPMENT: PLAN
FILING NUMBER:	N/A
PHASE NUMBER:	N/A
PREPARATION DATE:	04/15/2016
REVISION DATE:	06/20/2016
REVISION DATE:	07/01/2016
REVISION DATE:	08/18/2016
REVISION DATE:	09/29/2016
REVISION DATE:	
	SHEET 10 OF 15

DRAWN BY: T. WAUGH

NE, COLORADO

TECH CENTER

TOWN OF FIRESTONE,

tes architecture plann

h & associates


FIRESTONE

DATE: 15 APRIL 2016

ADDRESS AND TRAFFIC CONTROL PLAN

## BLUESTEM TECH CENTER

LIGHTING SITE PLAN TOWN OF FIRESTONE, WELD COUNTY, STATE OF COLORADO **SHEET 11 OF 15** 

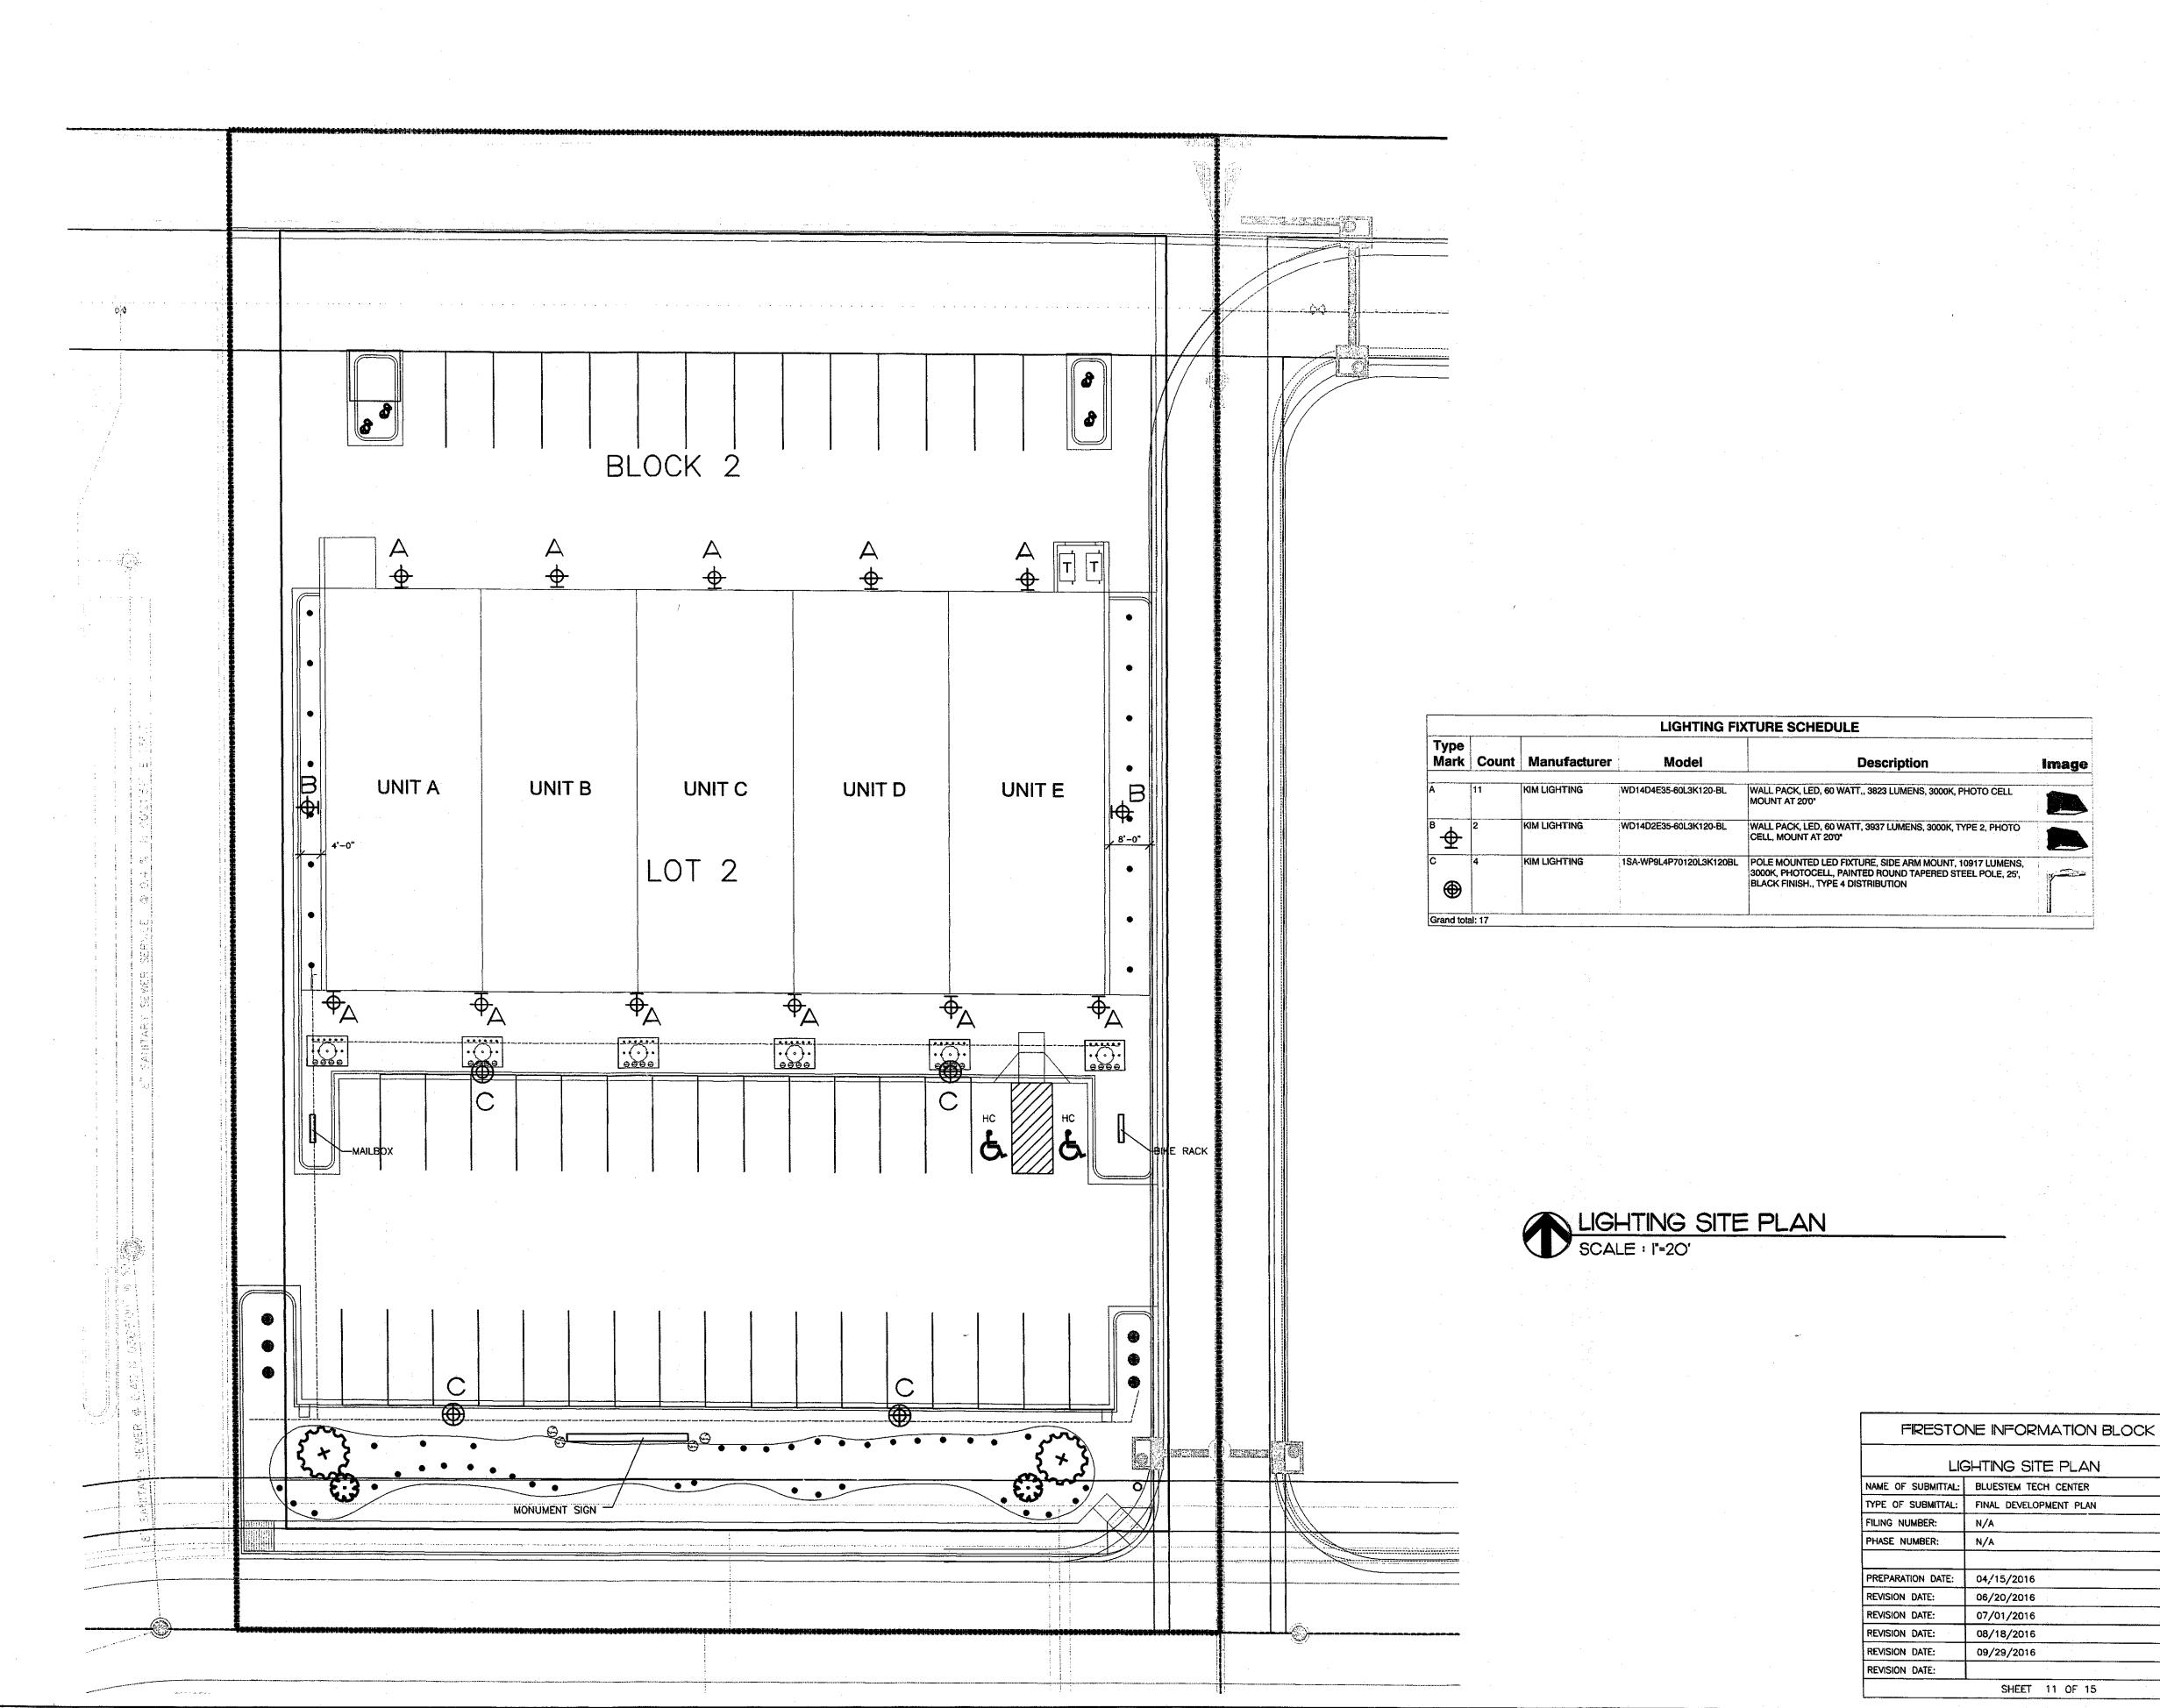


TECH

FIRESTONE

DATE: 15 APRIL 2016

LIGHTING SITE PLAN

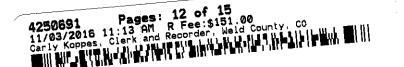

Detail Filled Region

FINAL DEVELOPMENT PLAN

# BLUESTEM TECH CENTER

PHOTOMETRIC PLAN TOWN OF FIRESTONE, WELD COUNTY, STATE OF COLORADO SHEET 12 OF 15

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H %	48304
巨只象	7-6-16
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**GUST ENGINEERING** 2319 CREEKWOOD DRIVE FORT COLLINS, COLORADO 80525 mgust@gustengineering.com

**GUST ENGINEERING** 3612 PIONEER AVENUE CHEYENNE, WYOMING 82001 307-638-2511 mgust@gustengineering.com

**REVISIONS:** 

COLORADO

CENTER OF FIRESTONE,

TECH

FIRESTONE

15 APRIL 2016

PHOTOMETRIC

				•
		WP9LP-LED		
KIM LIGHTING		Large, PicoPrism™ LED		
Type: Job:	tevision 1	2/16/14 • kim_wp9lpled_spec.pdf Approvals:	KIM LIGHTING	
Catalog number:			Type: Job: Catalog number:	Market
Atta Fixture Street a Street and About the Fines Octobs Select pole from Kin's Arms and Poles Selection Guide. If pole is provided I		Date: Page: 1 of 6	interio Electrical Modelo Finish Options See page 3	4
1 5 mm 10 5/18 555/16 (151 mm FRONT SIDE	alloy with integral cooling ribs Solid barrier wall separates optic Electronic Module: All electr recognized, mounted on a sing quick-disconnect plugs. Module device and surge protector. Ele with no-tool hinges and latche and has a 0-10V dimming int options.  Optical Module: Precision, positioned to achieve direction entire light engine fastens to the Dimming: Driver has a 0-10V range of 10-100%. Approved dutton Nova NFTV and NTFTV sourcing dimmers.  Support Arm: Heavy cast, stainless steel mounting bolts, with wire strain relief. Arm is cir Finish: Each luminaire receivelectrostatically applied, therm (TGIC) polyester powdercoat Black. (DB) Dark Bronze, (WI Stealth Gray, (LG) Light Gray RAL#).  Listed to: UL 1598 Standard for Safety for Light Emitting Diode Products and CSA C22.2#25 Meets Buy American provision Warranty: Kim Lighting warransold by Kim Lighting to be workmanship for (i) a period	ical components are UL and CSA le plate and factory prewired with e includes a driver, thermal control ctrical module attaches to housing s. Driver is rated for -40°F statting erface for multi-level illumination  IP66 replaceable PicoPrisms are al control toward desired task. The housing as a one-piece module dimming interface with a dimming limmers include Lutron Diva AVTV, . Note: Not compatible with current  low copper aluminum alloy with A pole reinforcing plate is provided cular cut for specified round pole.  ves a fade and abrasion resistant, hally cured, triglycidal isocyanurate finish. Standard colors include (BL) H) White, (PS) Platinum Silver, (SG) H, and (CC) Custom Color (Include  or Luminaires - UL 8750 Standard for (LED) Equipment for use in Lighting 50.0 Luminaires. RoHS compliant: s within ARRA.  hts Warp9 LED products ("Product(s)") free from defects in material and of five (5) years for metal parts, (ii)	Specifications WD14-LED 60 Light Emitting Diodes Total Max System Watts = 65W Maximum Weight = 26 lbx.  TOP 73/37 (137 20 14 5/3" 20	Optical Housing: integral cooling fit with degree markers view above horizon Geer Housing: On cooling fins, Eastern and wiring. One state housing to rotate for scaling provided by with the fixture on.  Lens Frame: One hinges and stainless a one-piece extrude glass sealed to lens mounted on a plugs. Module include attaches to the lens frame or interface for multi-Optical Module: directional control one-piece module. Mounting Plate: All mounting pla provided in each Sealant must be a to insure a day junc Finish: Each lumin thermally cured, toolors include (BL) Gray, (LG) Light G Lieted To: UL 15 Ensitting Dlode (L Luminaires.  Warranty: Kim Lighting to be free years for metal pair
	period of six (6) years for LED a period of five (5) years for L LifeShield <sup>®</sup> device), from the d as specified in Kim Lighting sh	exterior housing paint finish(s), (iii) a Light Engines (PicoPrisms <sup>11</sup> and, (iv) ED power components (LED Driver, ate of sale of such goods to the buyer ripment documents for each product, rotector, dimmers and relay whing the manufacturer's warranty.	4½* (143 nm) To J-box center SiDE	period of six (6) ye components (drive goods to the buye CAUTION: Fixtur electrical codes. F

CAUTION: Fixtures must be grounded in accordance with national, state and/or local electrical codes, Failure to do so may result in

Model

WD14D4E35-60L3K120-BL

WD14D2E35-60L3K120-BL

LIGHTING FIXTURE SCHEDULE

MOUNT AT 20'0"

CELL, MOUNT AT 20'0"

1SA-WP9L4P70120L3K120BL POLE MOUNTED LED FIXTURE, SIDE ARM MOUNT, 10917 LUMENS,

BLACK FINISH., TYPE 4 DISTRIBUTION

HUBBERLL HUBBERLL HUBBERLL U.S. Patent D568,521, Patent Pending Optics

Grand total: 17

© 2014 KIM LIGHTING + 16555 EAST GALE AVENUE, CITY OF INDUSTRY, CA 91745-1788 • TEL: 626:968-5666 • FAX: 626:968-5716

Mark Count Manufacturer


KIM LIGHTING

KIM LIGHTING

KIM LIGHTING

ElumTools General Use Illuminance Results

Calculation Points Name | Average | Minimum | Maximum

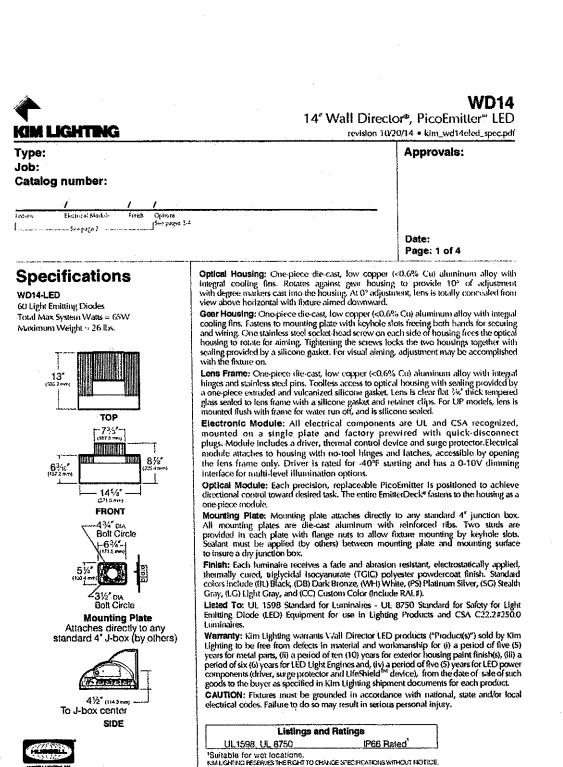

Description

WALL PACK, LED, 60 WATT,, 3823 LUMENS, 3000K, PHOTO CELL

WALL PACK, LED, 60 WATT, 3937 LUMENS, 3000K, TYPE 2, PHOTO

3000K, PHOTOCELL, PAINTED ROUND TAPERED STEEL POLE, 25',

Image


2 VOX	
WFR @ 0.4% N	
	0 0 0 1 1 2 3 4 5 5 4 3 2 1 1 1 1 0 1 1 1 2 3 4 5 5 4 3 2 1 1 1 0 0 0 0 0 0 0 0 0 0 0 0 0 0 0 0
	1 1 1 2 2 4 5 6 6 5 4 2 2 2 2 1 1 1 1 1 2 2 3 4 6 8 9 10 9 8 6 4 3 2 1 1 1 1 0 0 0
8" SANITARY SE	1 2 3 3 A3 3 3 3 A3 3 3 3 A3 3 3 3 A3 3 3 A3 A
SEWER SERVICE @ C	
0	UNIT B UNIT C UNIT C UNIT B UNIT C UN
1 — — 0  ElumTools Default Analysis	
6-   4-   3-	
8- 7-	
10	

FIRESTO	NE INFORMATION BLOCK
PL	IOTOMETRIC PLAN
NAME OF SUBMITTAL:	BLUESTEM TECH CENTER
TYPE OF SUBMITTAL:	FINAL DEVELOPMENT PLAN
FILING NUMBER:	N/A
PHASE NUMBER:	N/A
PREPARATION DATE:	04/15/2016
REVISION DATE:	06/20/2016
REVISION DATE:	07/01/2016
REVISION DATE:	08/18/2016
REVISION DATE:	09/29/2016
REVISION DATE:	

1 SITE LIGHTING INFORMATION
1/16" = 1'-0"

# BLUESTEM TECH CENTER

OVERALL MAIN LEVEL PLAN
TOWN OF FIRESTONE, WELD COUNTY, STATE OF COLORADO
SHEET 13 OF 15

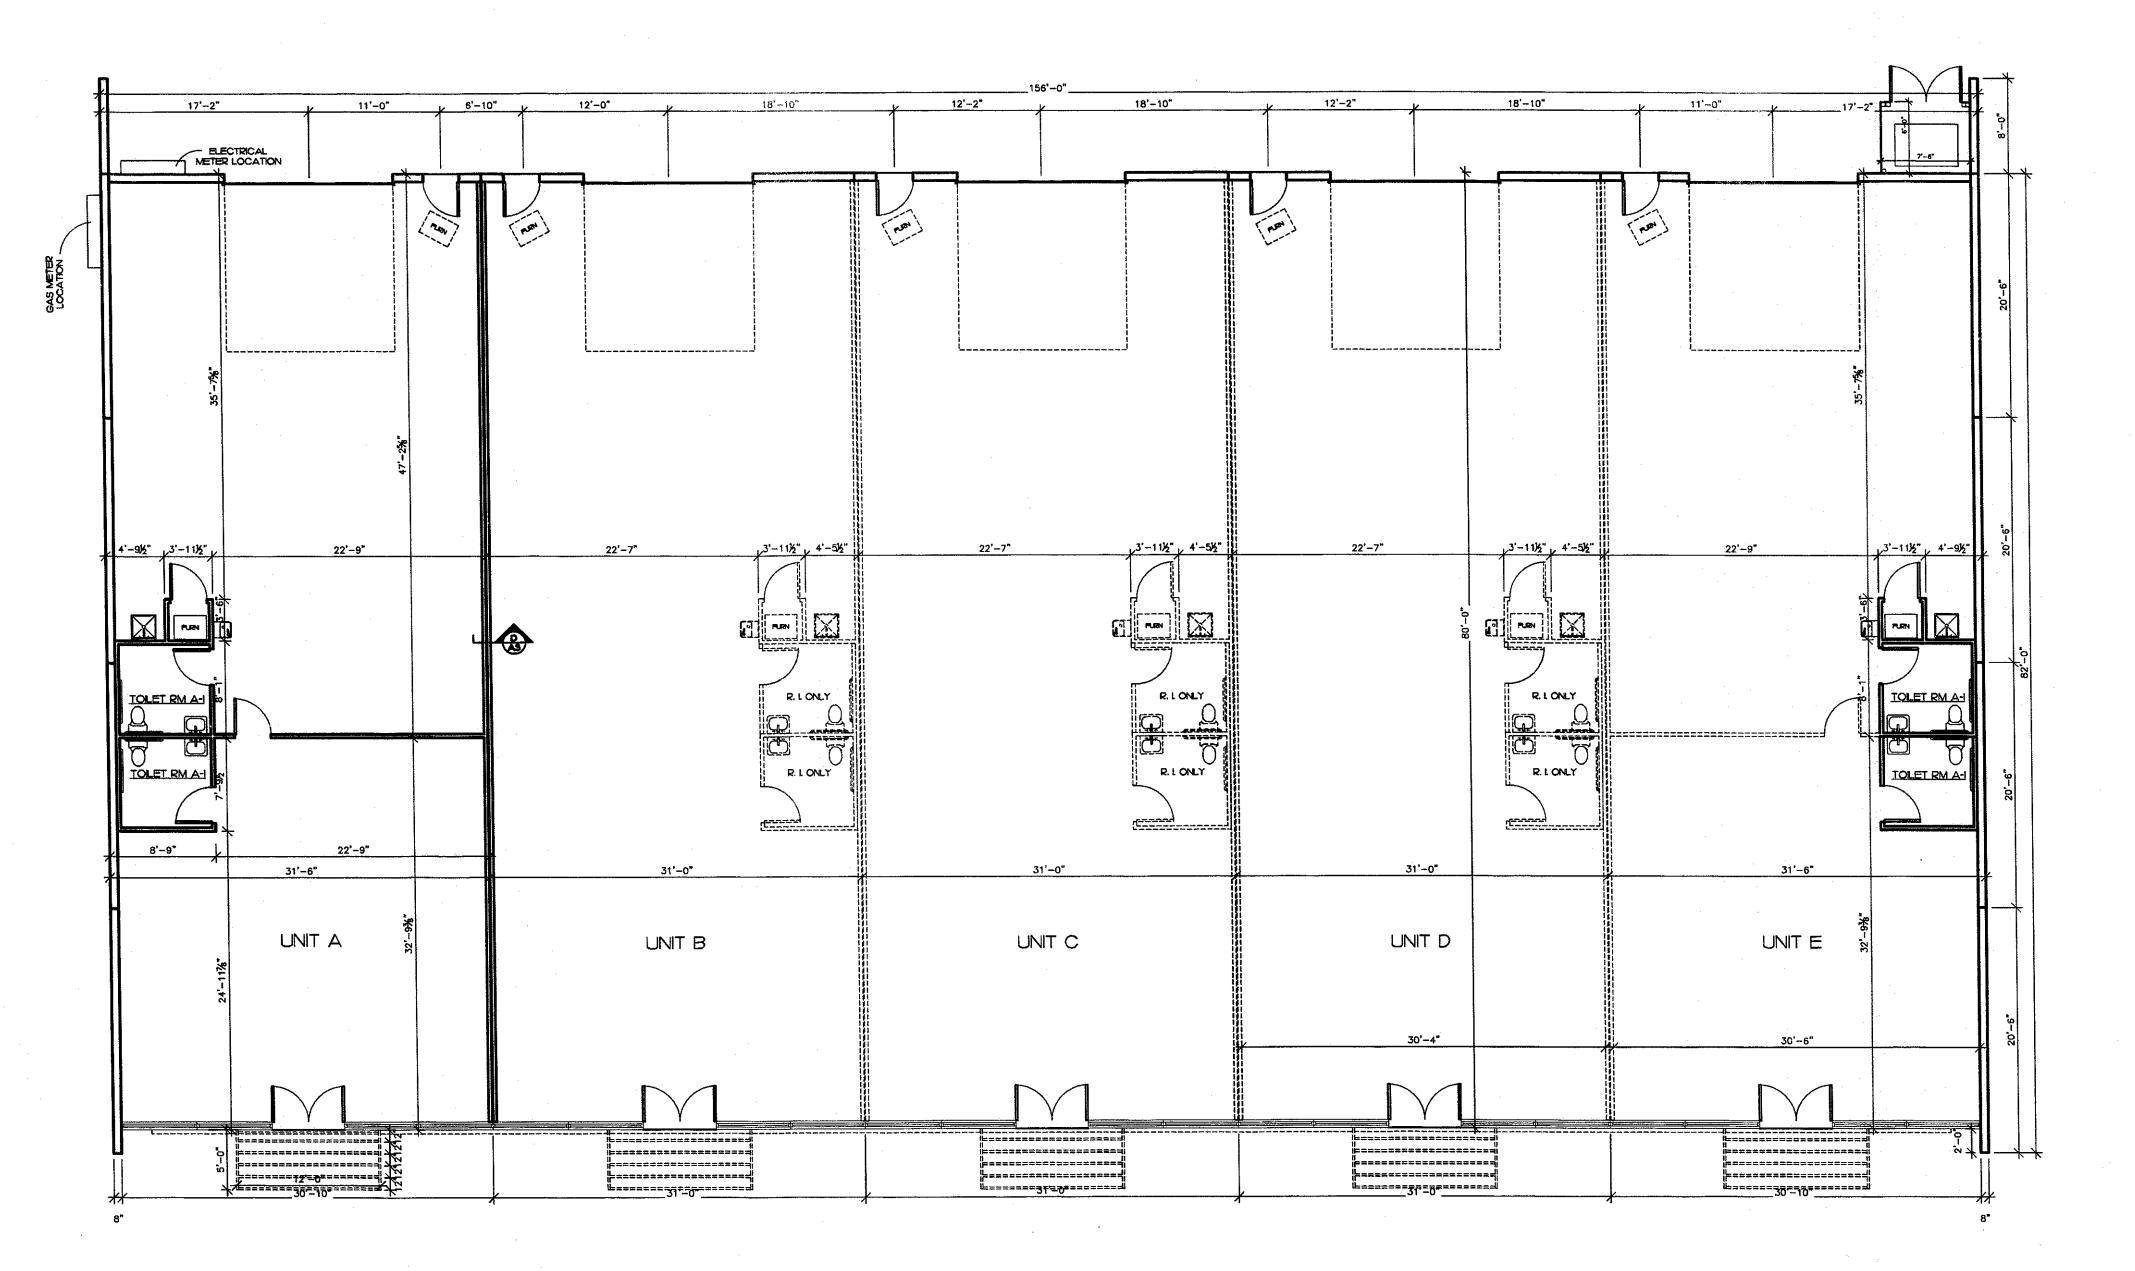



FIRESTO	NE INFORMATION BLOCK
	FLOOR PLAN
NAME OF SUBMITTAL:	BLUESTEM TECH CENTER
TYPE OF SUBMITTAL:	FINAL DEVELOPMENT PLAN
FILING NUMBER:	N/A
PHASE NUMBER:	N/A
PREPARATION DATE:	04/15/2016
REVISION DATE:	06/20/2016
REVISION DATE:	07/01/2016
REVISION DATE:	08/18/2016
REVISION DATE:	09/29/2016
REVISION DATE:	

SHEET 13 OF 15

EVISIONS:

DRAWN BY: T WALK

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DATE: 15 APRIL 2016

FLOOR PLAN


FIRESTONE

4250691 Pages: 14 of 15
11/03/2016 11:13 AM R Fee:\$151.00
Carly Koppes, Clerk and Recorder, Weld County, CO

### FINAL DEVELOPMENT PLAN

# BLUESTEM TECH CENTER

ELEVATIONS TOWN OF FIRESTONE, WELD COUNTY, STATE OF COLORADO SHEET 14 OF 15

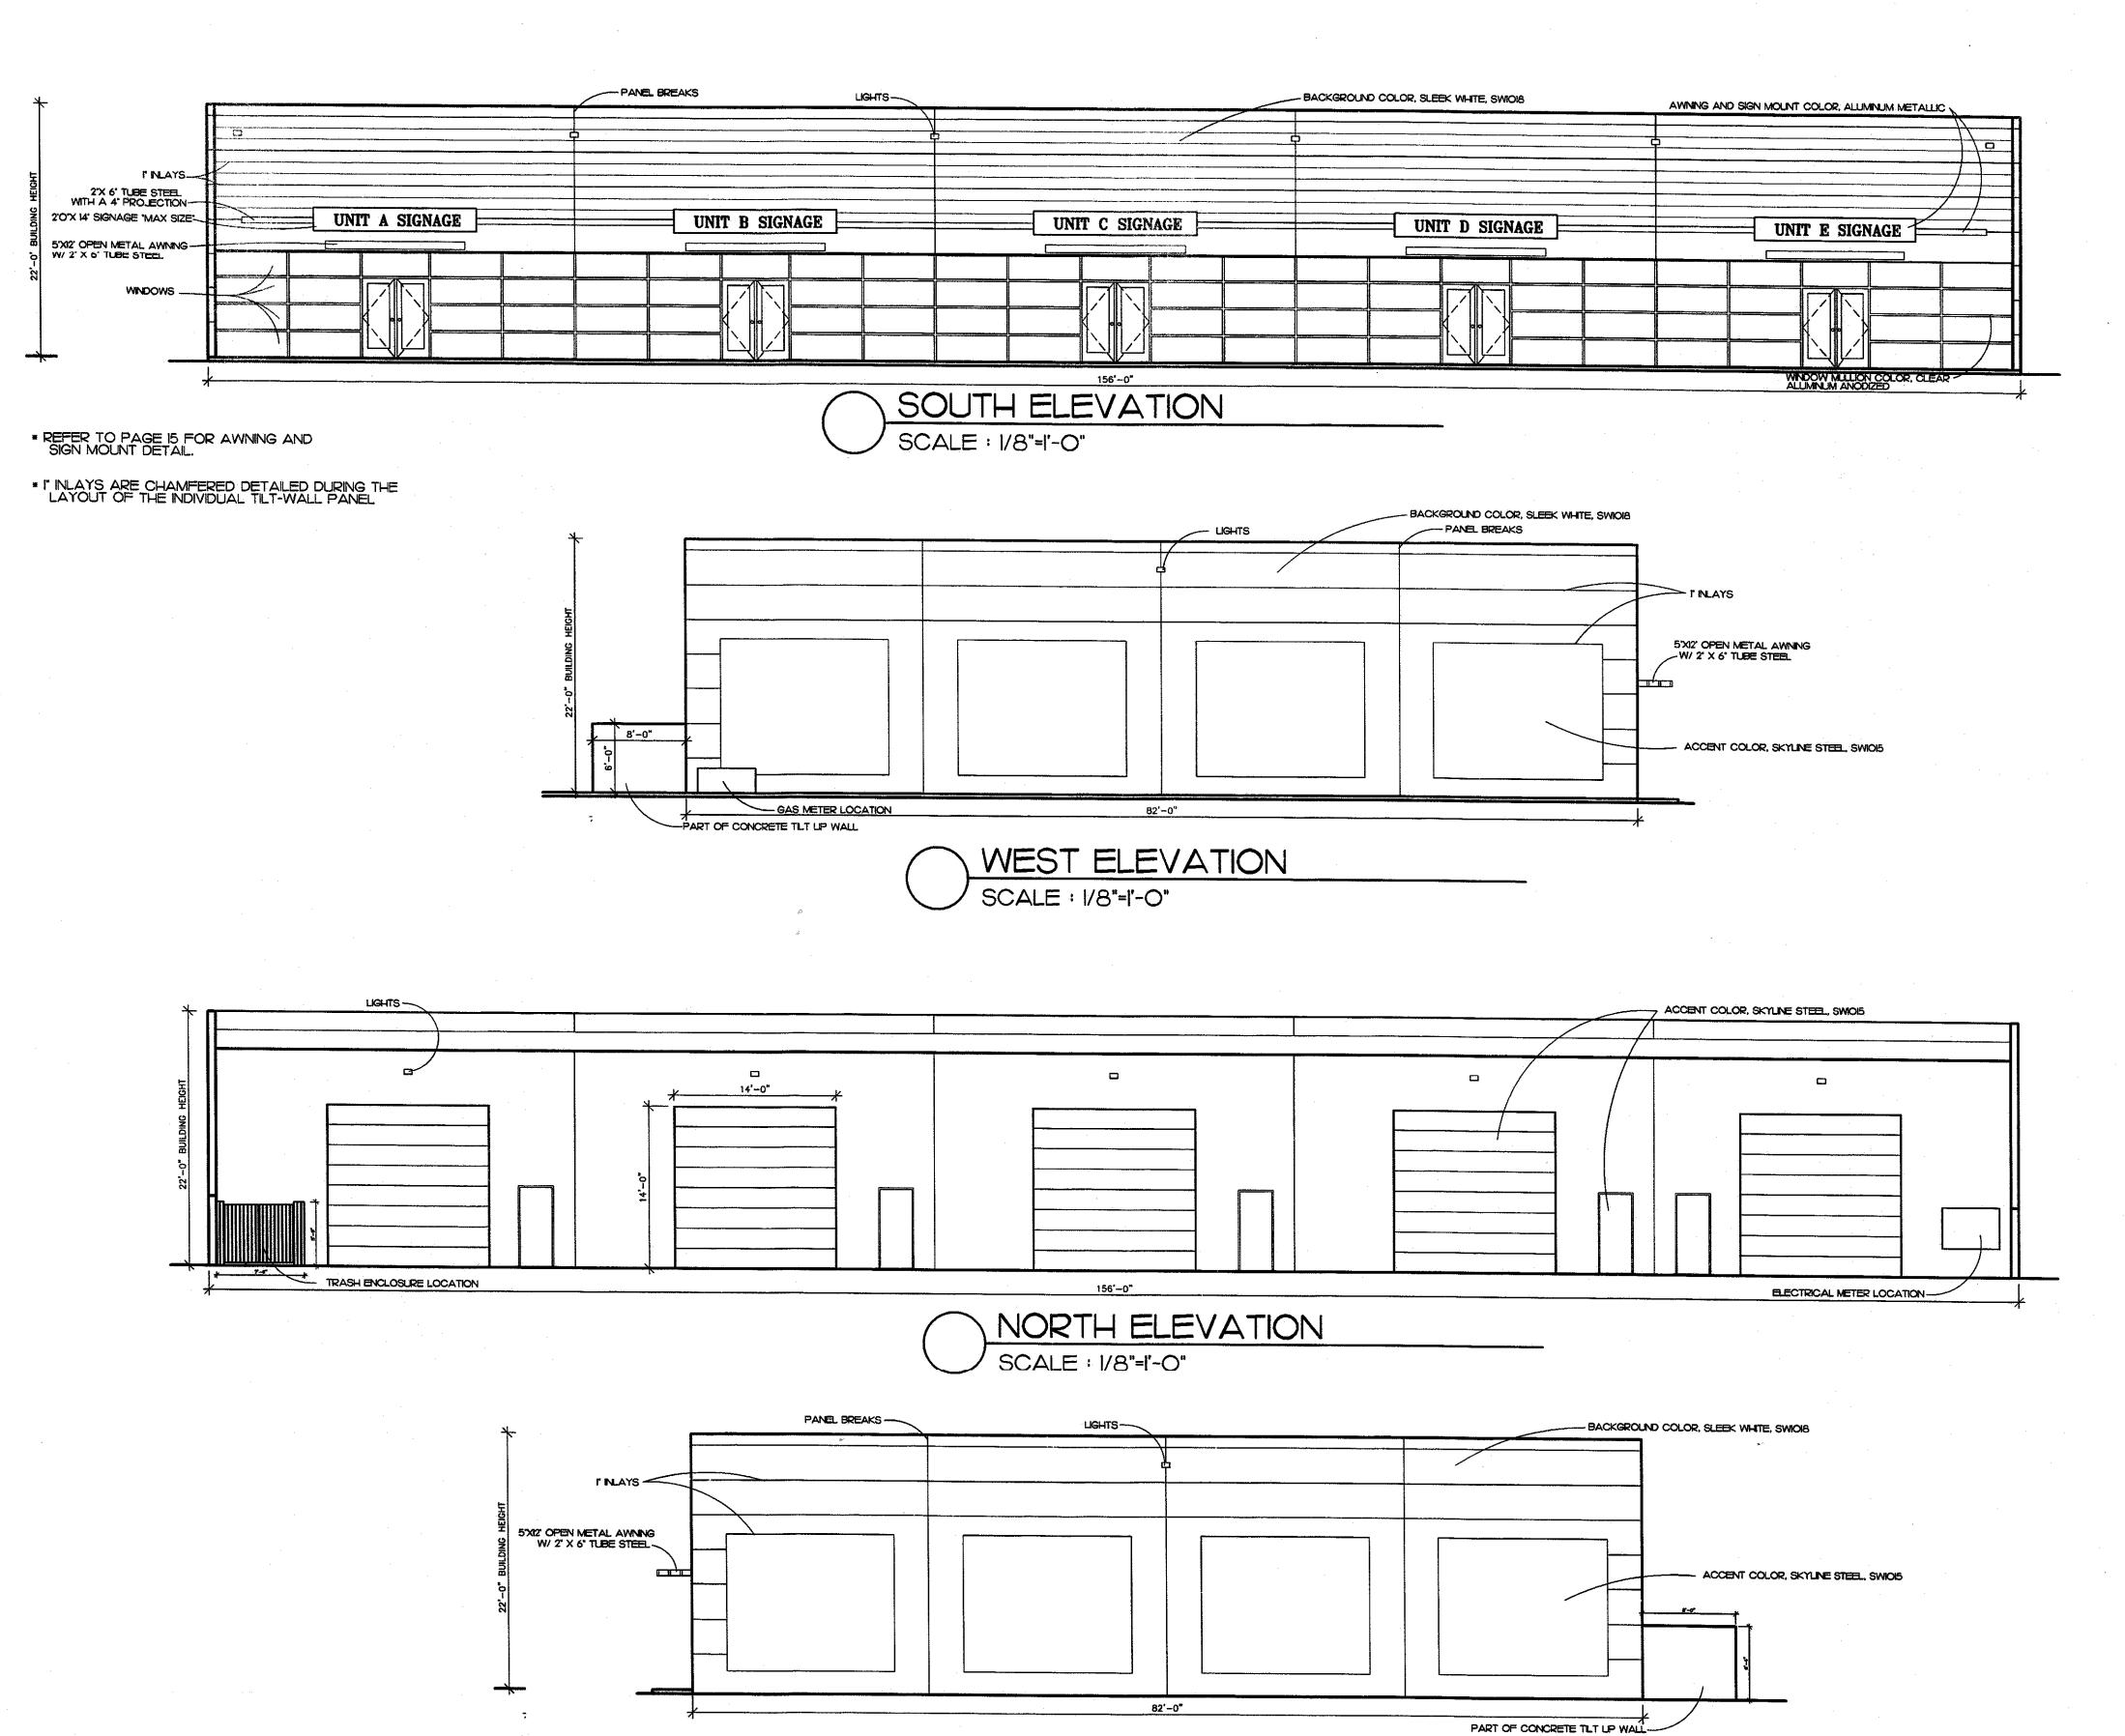

EAST ELEVATION

SCALE : 1/8"=1'-0"

FIRESTO	NE INFORMATION BLOCK
	ELEVATIONS
NAME OF SUBMITTAL:	BLUESTEM TECH CENTER
TYPE OF SUBMITTAL:	FINAL DEVELOPMENT PLAN
FILING NUMBER:	N/A
PHASE NUMBER:	N/A
PREPARATION DATE:	04/15/2016
REVISION DATE:	06/20/2016
REVISION DATE:	07/01/2016
REVISION DATE:	08/18/2016
REVISION DATE:	09/29/2016
REVISION DATE:	

REVISIONS:

DRAWN BY: T. WAUGH

CENTER

OF FIRESTONE, COLORADO architecture • planning • solar design

BLUESTEM TECH CENTER TOWN A associates

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FIRESTONE

DATE: 15 APRIL 2016

**ELEVATIONS** 

